

BVS Elevation Plans

HyNet Carbon Dioxide Pipeline DCO

Planning Act 2008


The Infrastructure Planning (Applications: Prescribed Forms and Procedure) Regulations 2009 –
Regulations 5(2)(o)

Document Reference Number D.2.8

Applicant: Liverpool Bay CCS Limited

PINS Reference: EN070007

English Version

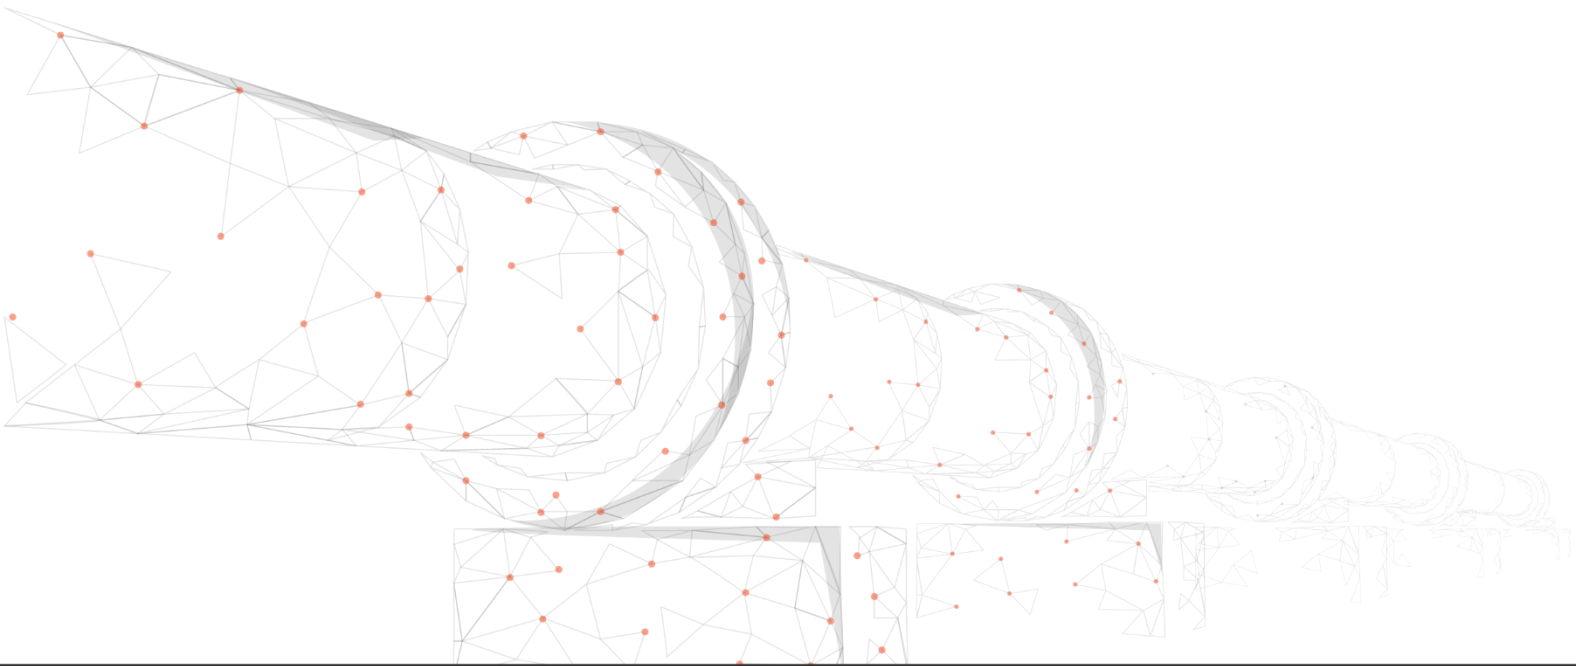

REVISION: B


DATE: March 2023

DOCUMENT OWNER: WSP UK Limited


PUBLIC

QUALITY CONTROL


Document Reference		D.2.8		
Document Owner		WSP		
Revision	Date	Comments	Author	Approver
A	September 2022	Submitted with DCO application	TO	AV
B	March 2023	Update for ES Addendum Design Change Request 1	TO	AV

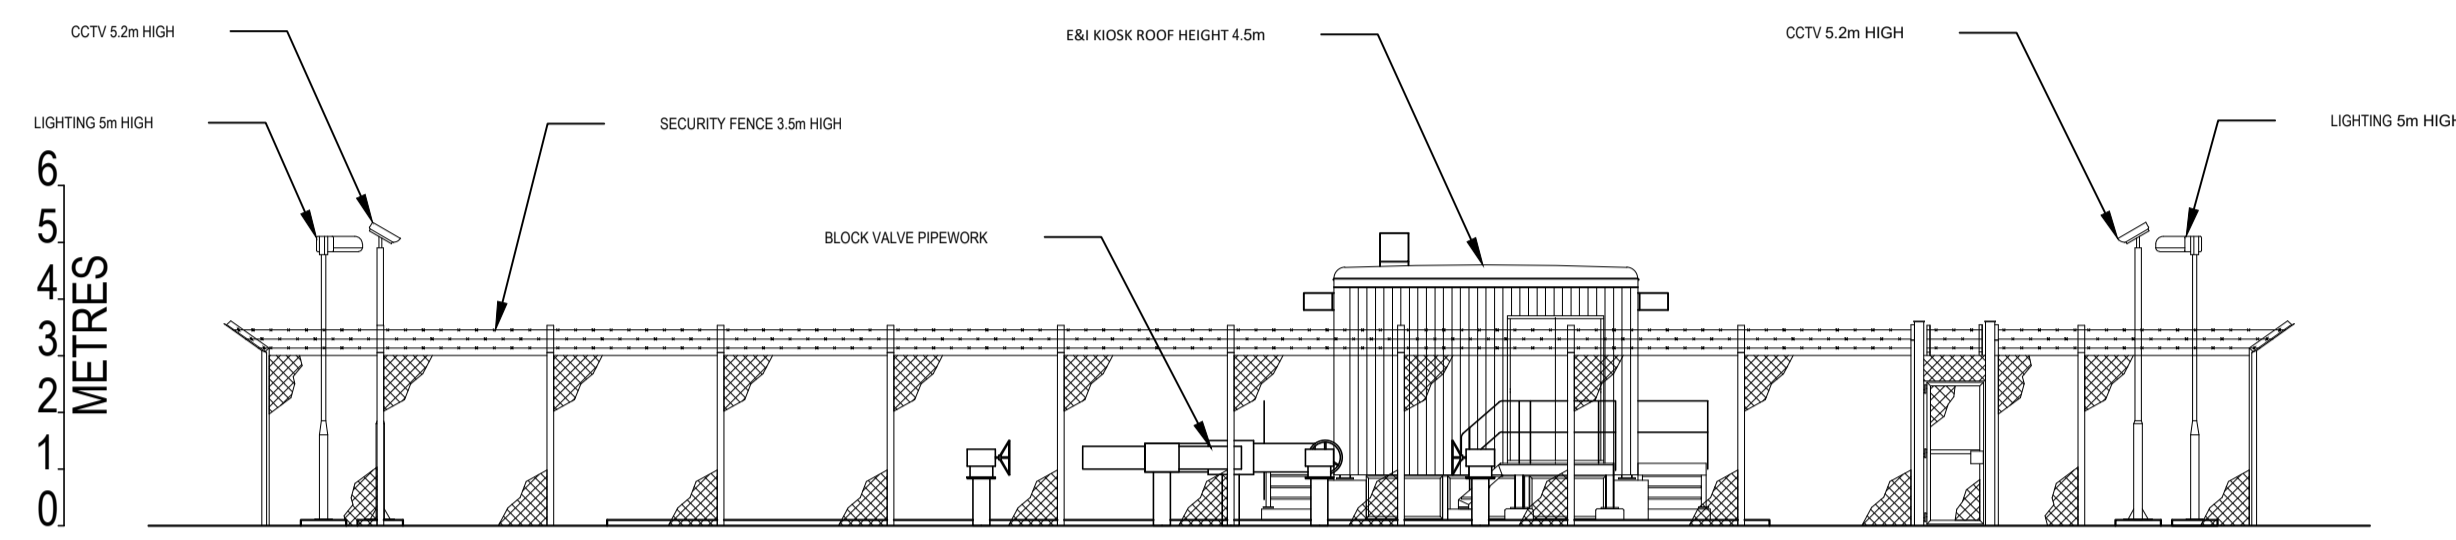


NORTH ELEVATION A-A

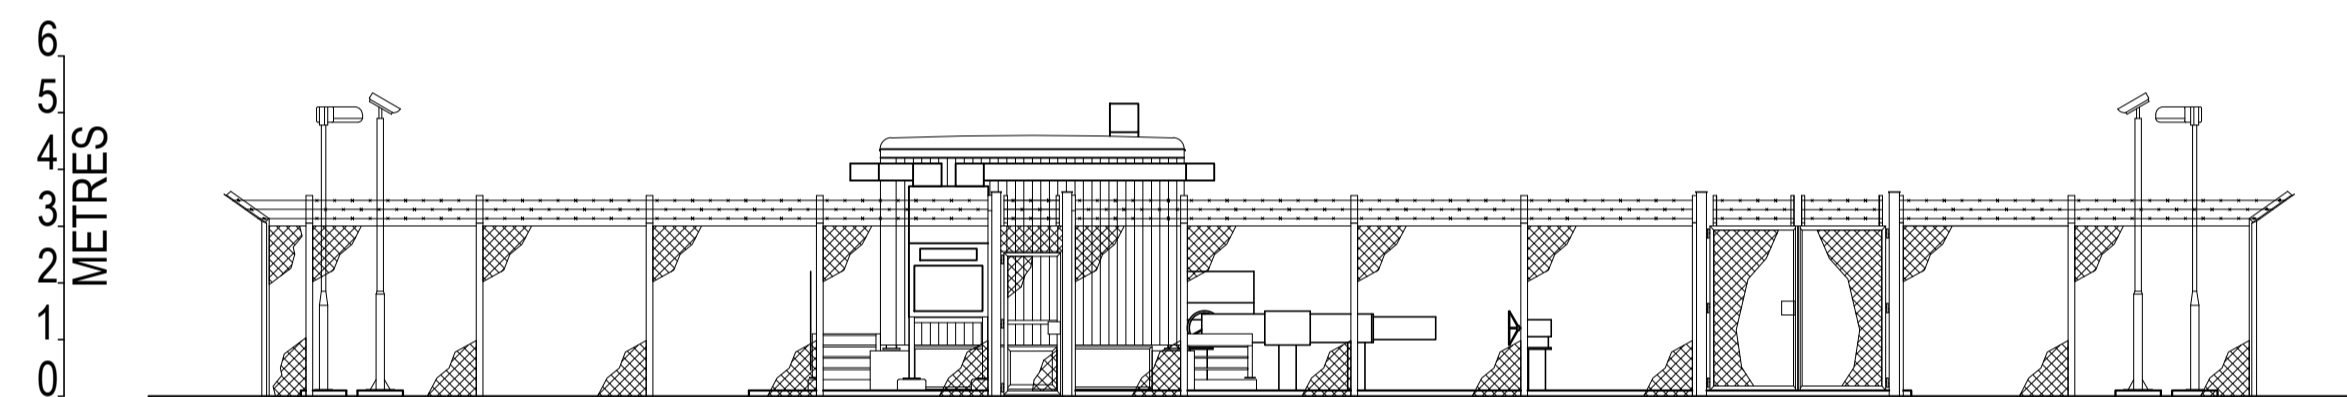




SOUTH ELEVATION B-B

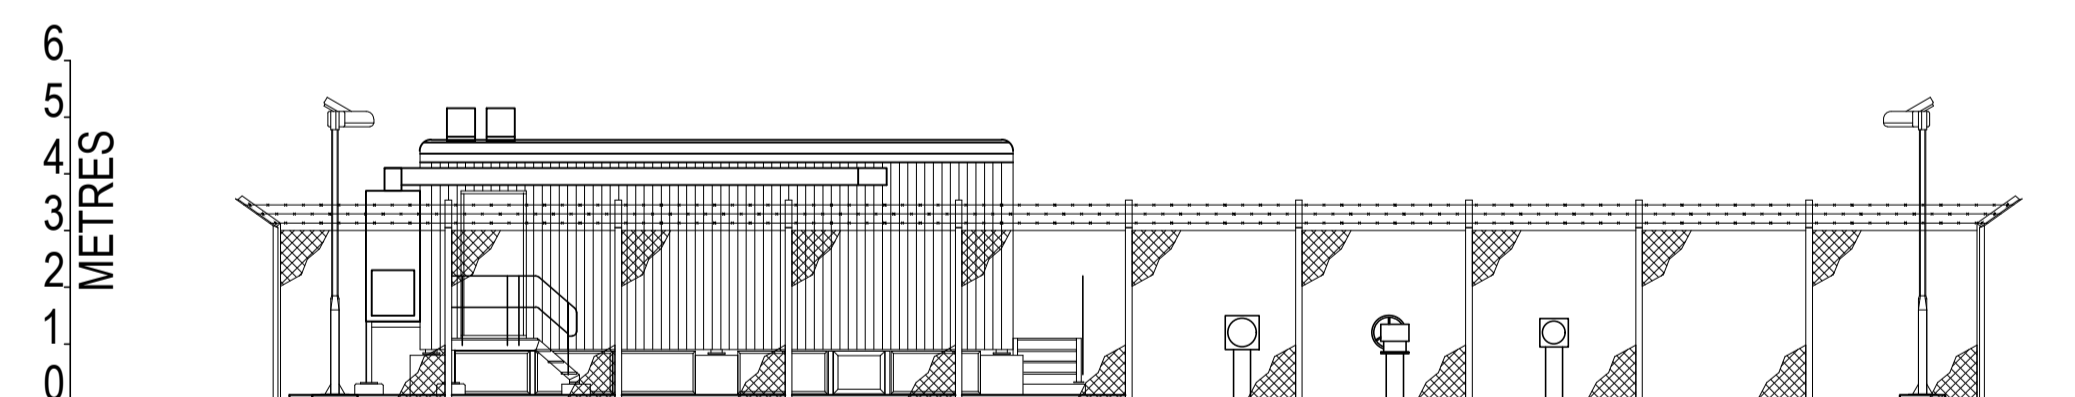

EAST ELEVATION C-C

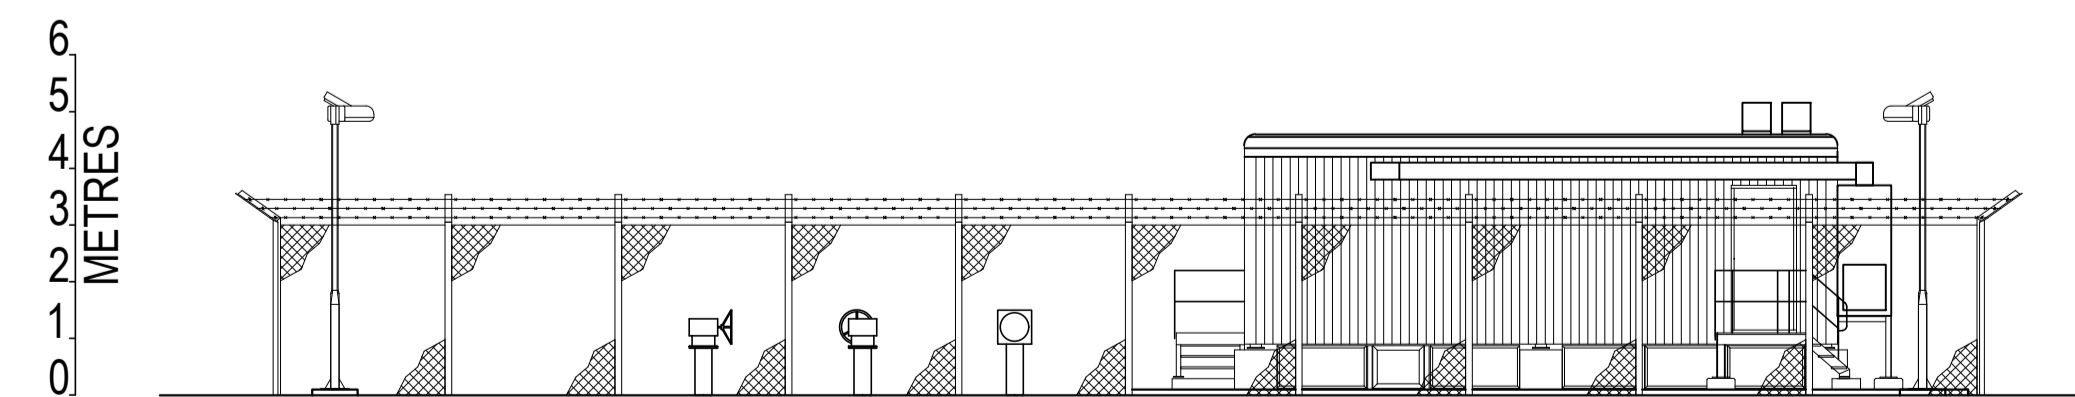

WEST ELEVATION D-D

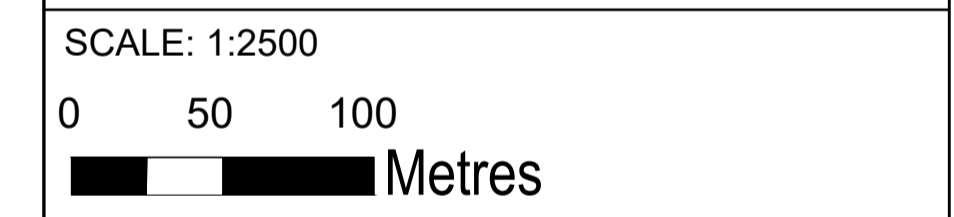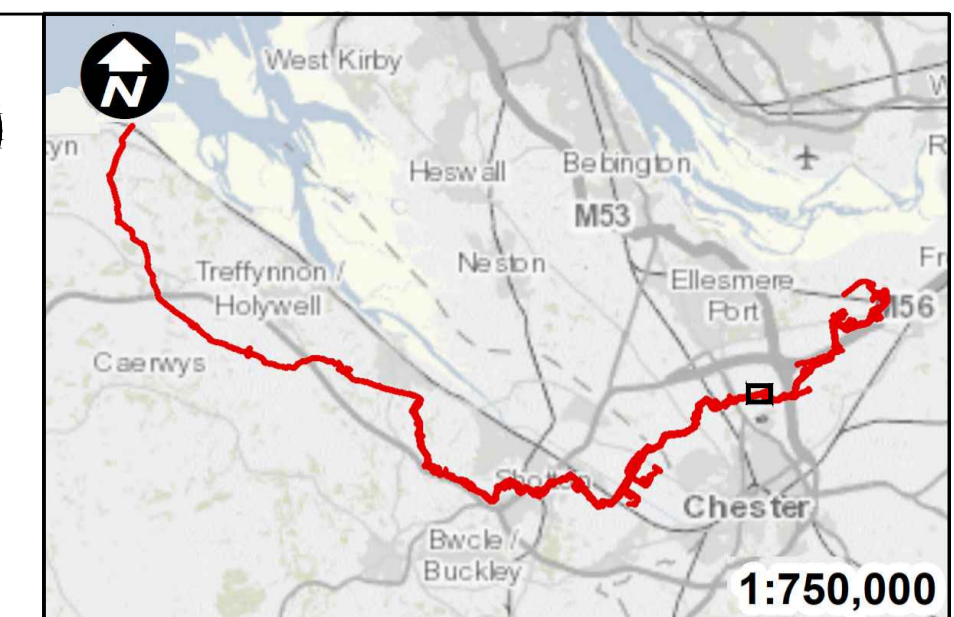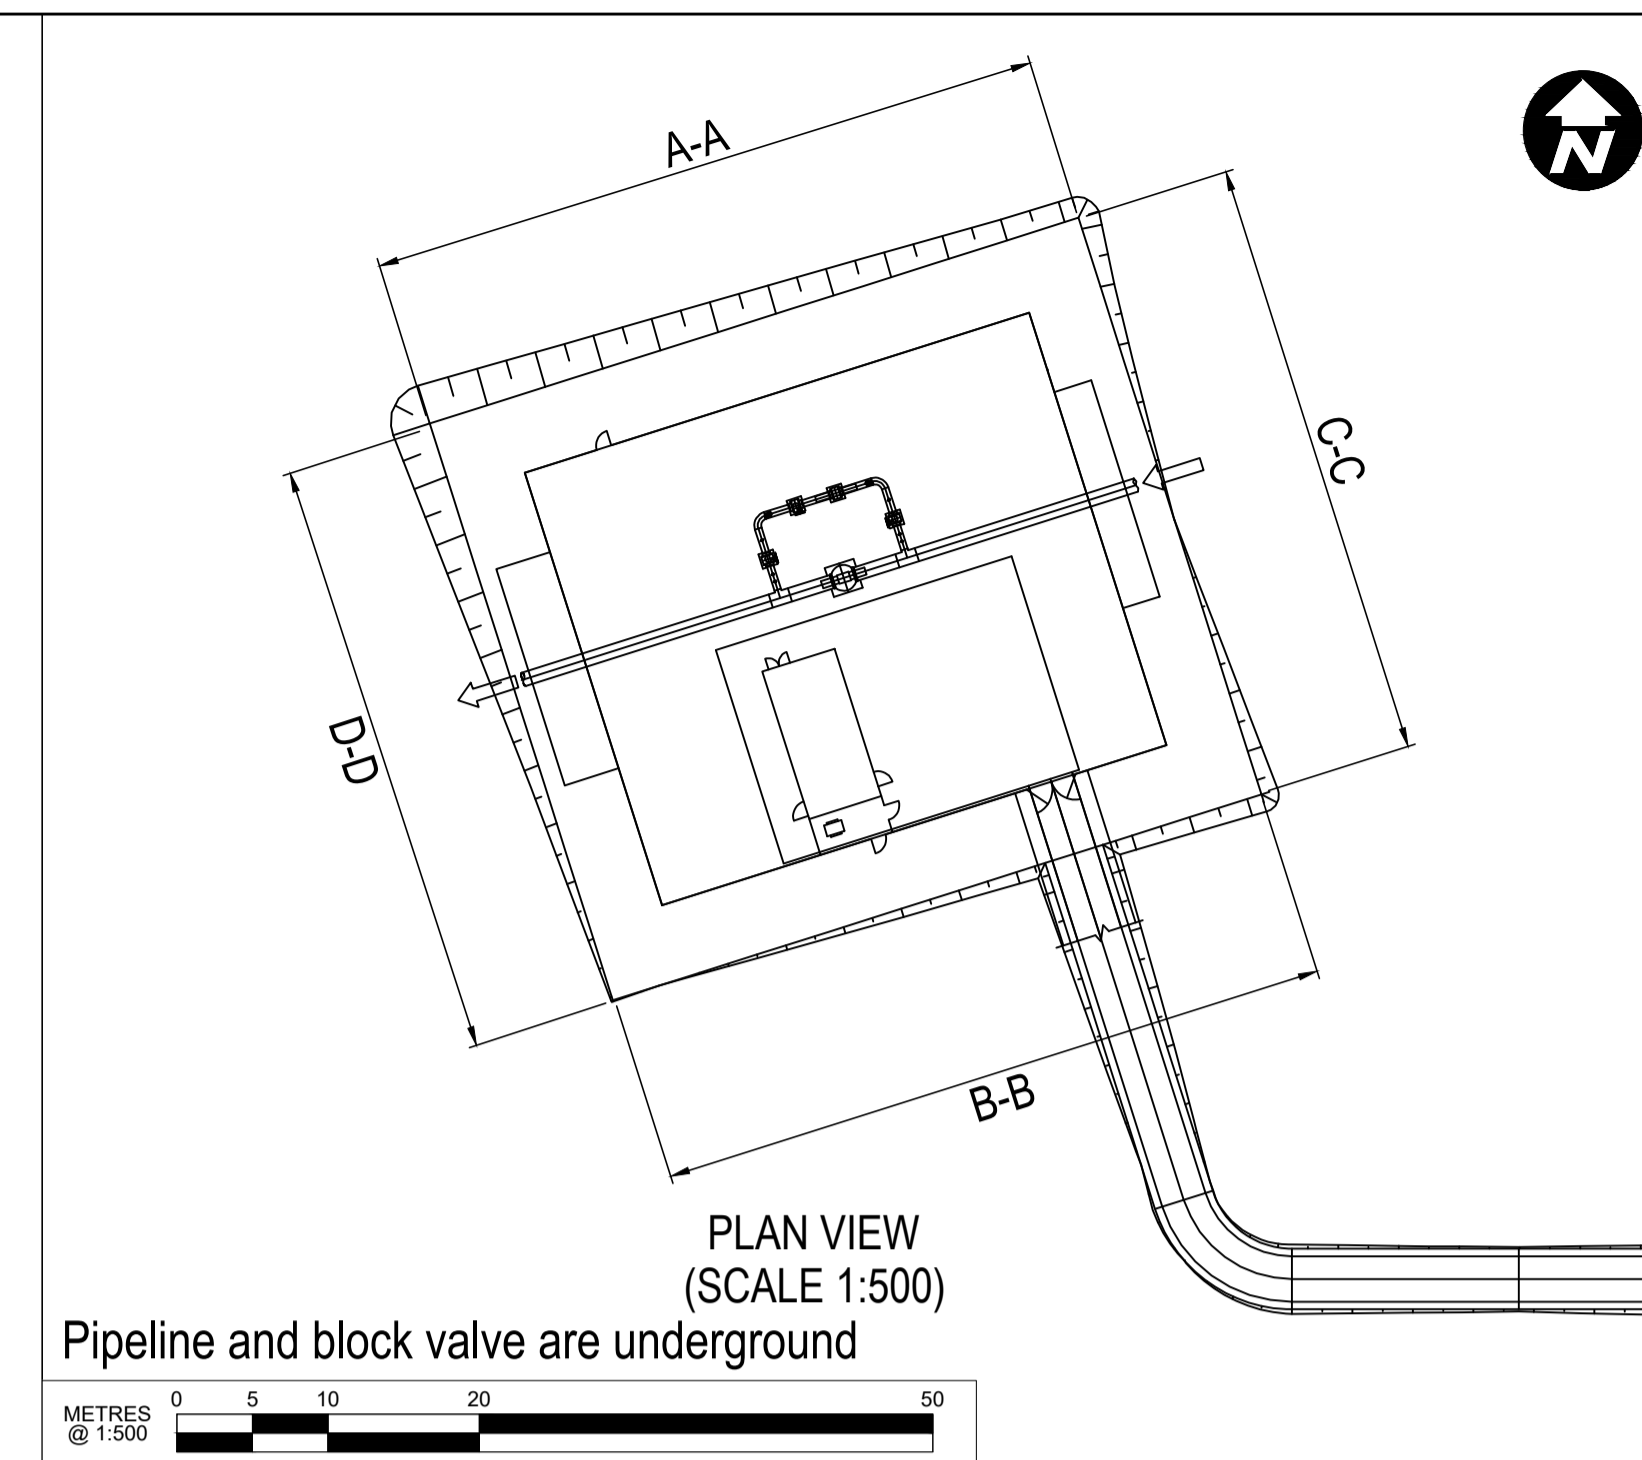

Contains OS data © Crown Copyright and database right 2020

HyNet North West

PROJECT TITLE
HyNet Carbon Dioxide Pipeline DCO


DRAWING TITLE
ROCK BANK BVS
ELEVATION PLAN
REGULATION 5(2)(o)
APPLICATION DOCUMENT REFERENCE D.2.8
SHEET 1 OF 6

DRAWING STATUS
FOR DESIGN CHANGE REQUEST 1


DRAWN TO	CHECKED JH	APPROVED VB	AUTHORISED AV
-------------	---------------	----------------	------------------

SCALE @ A1 SIZE 1:150	DATE 23/03/2023	REVISION B
--------------------------	--------------------	---------------


DRAWING NUMBER
EN070007-D.2.8-EL-Sheet 1

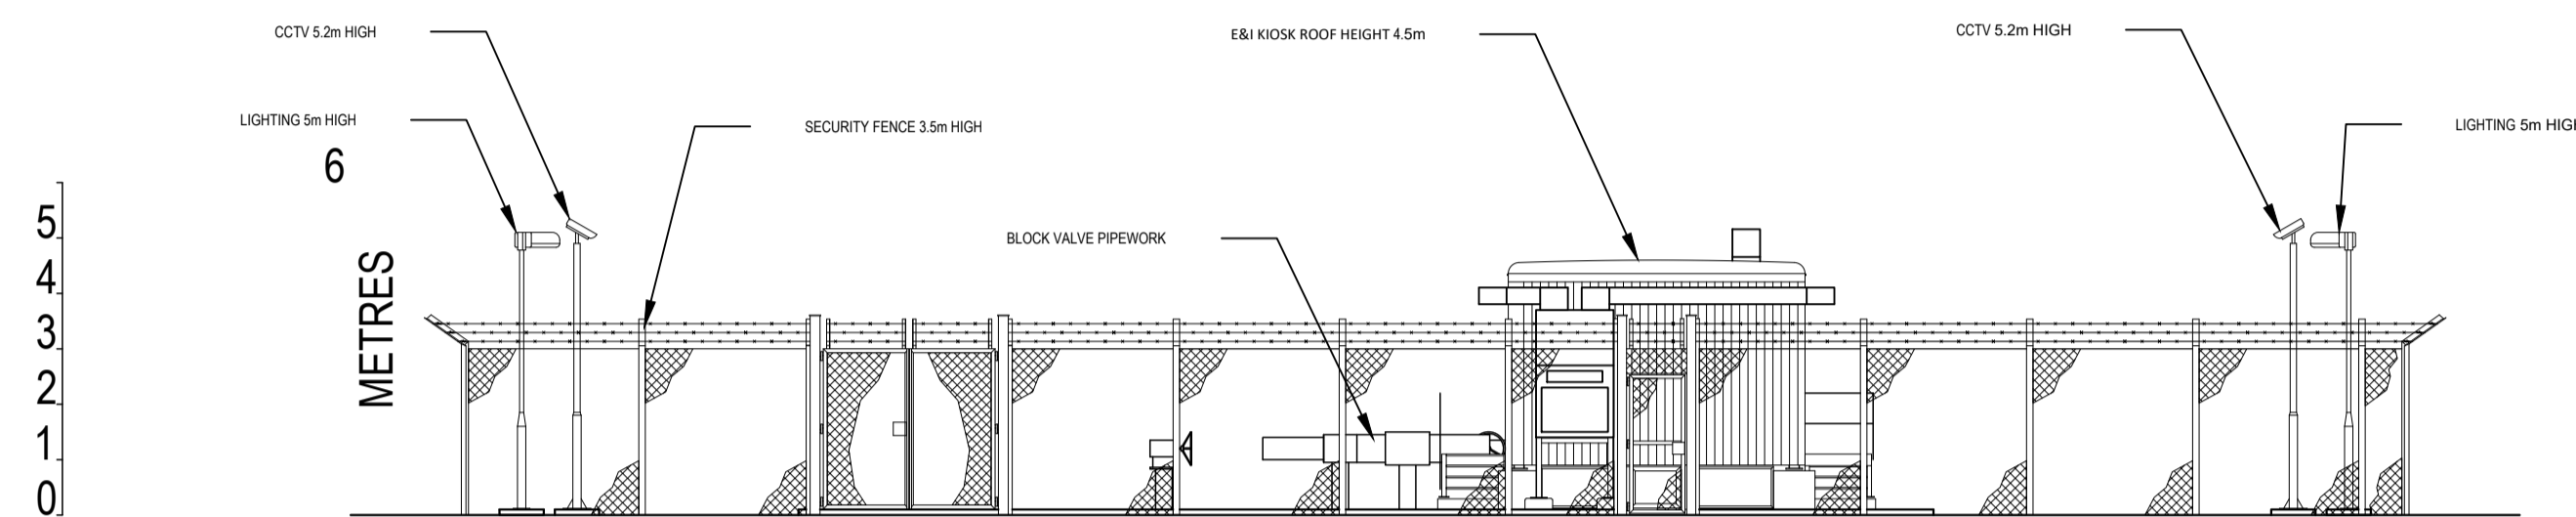


NORTH ELEVATION A-A

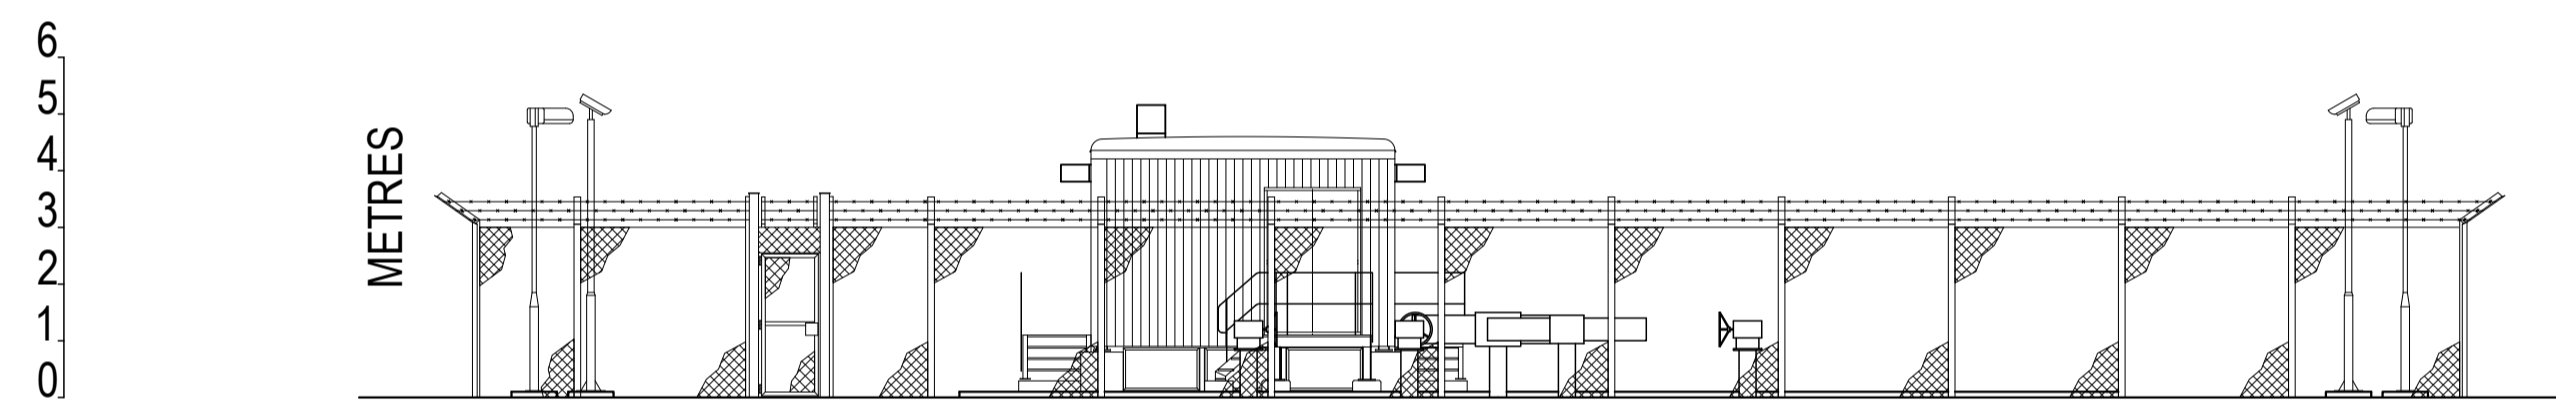


SOUTH ELEVATION B-B

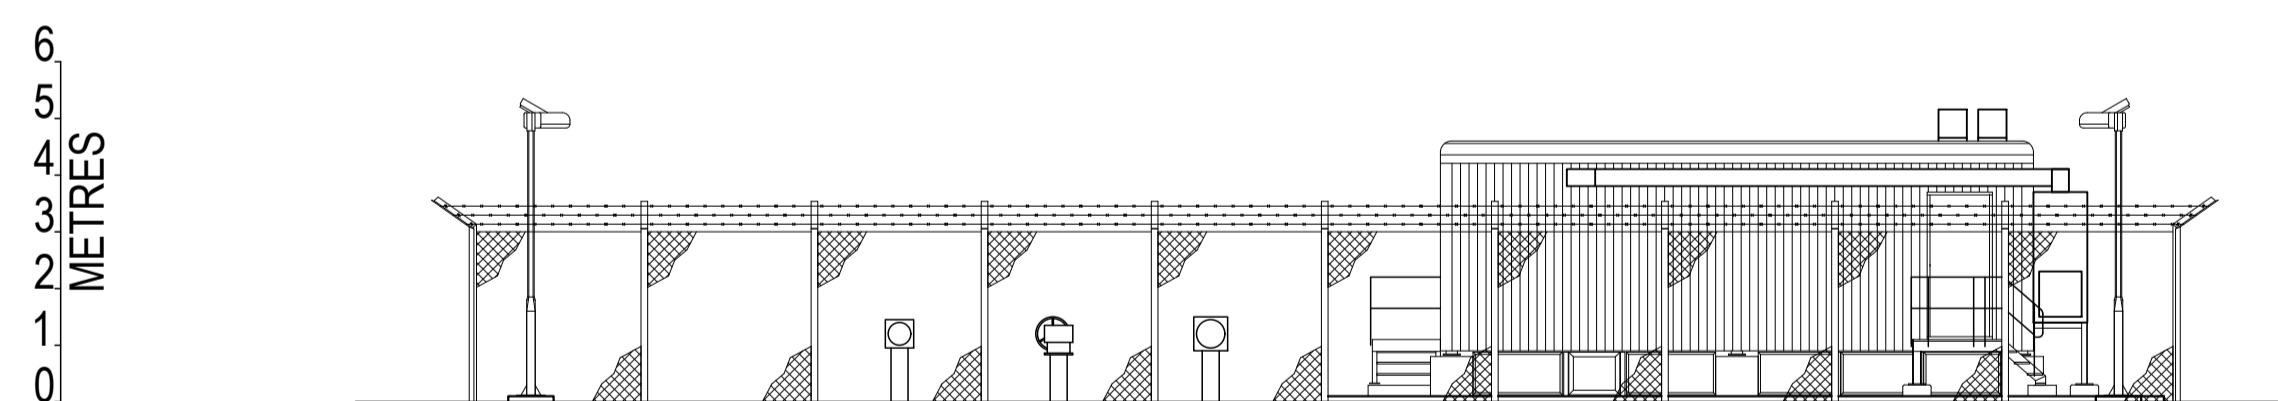


EAST ELEVATION C-C

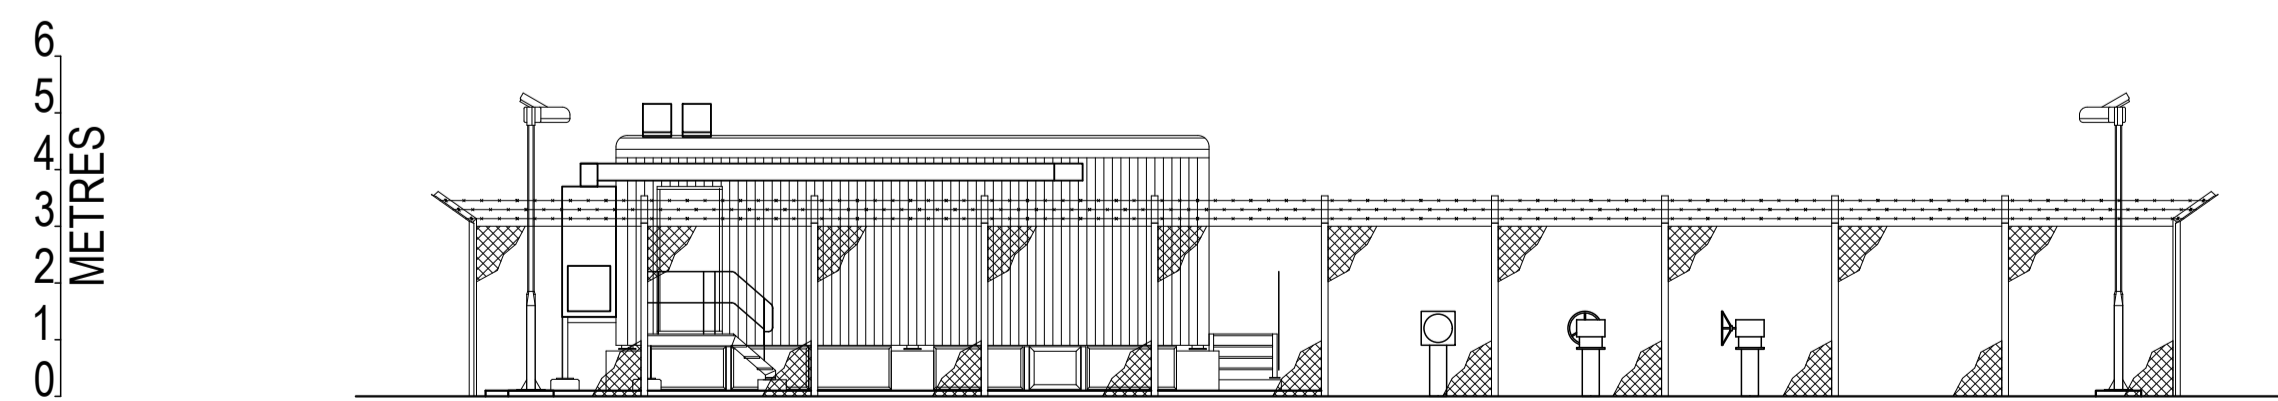


WEST ELEVATION D-D

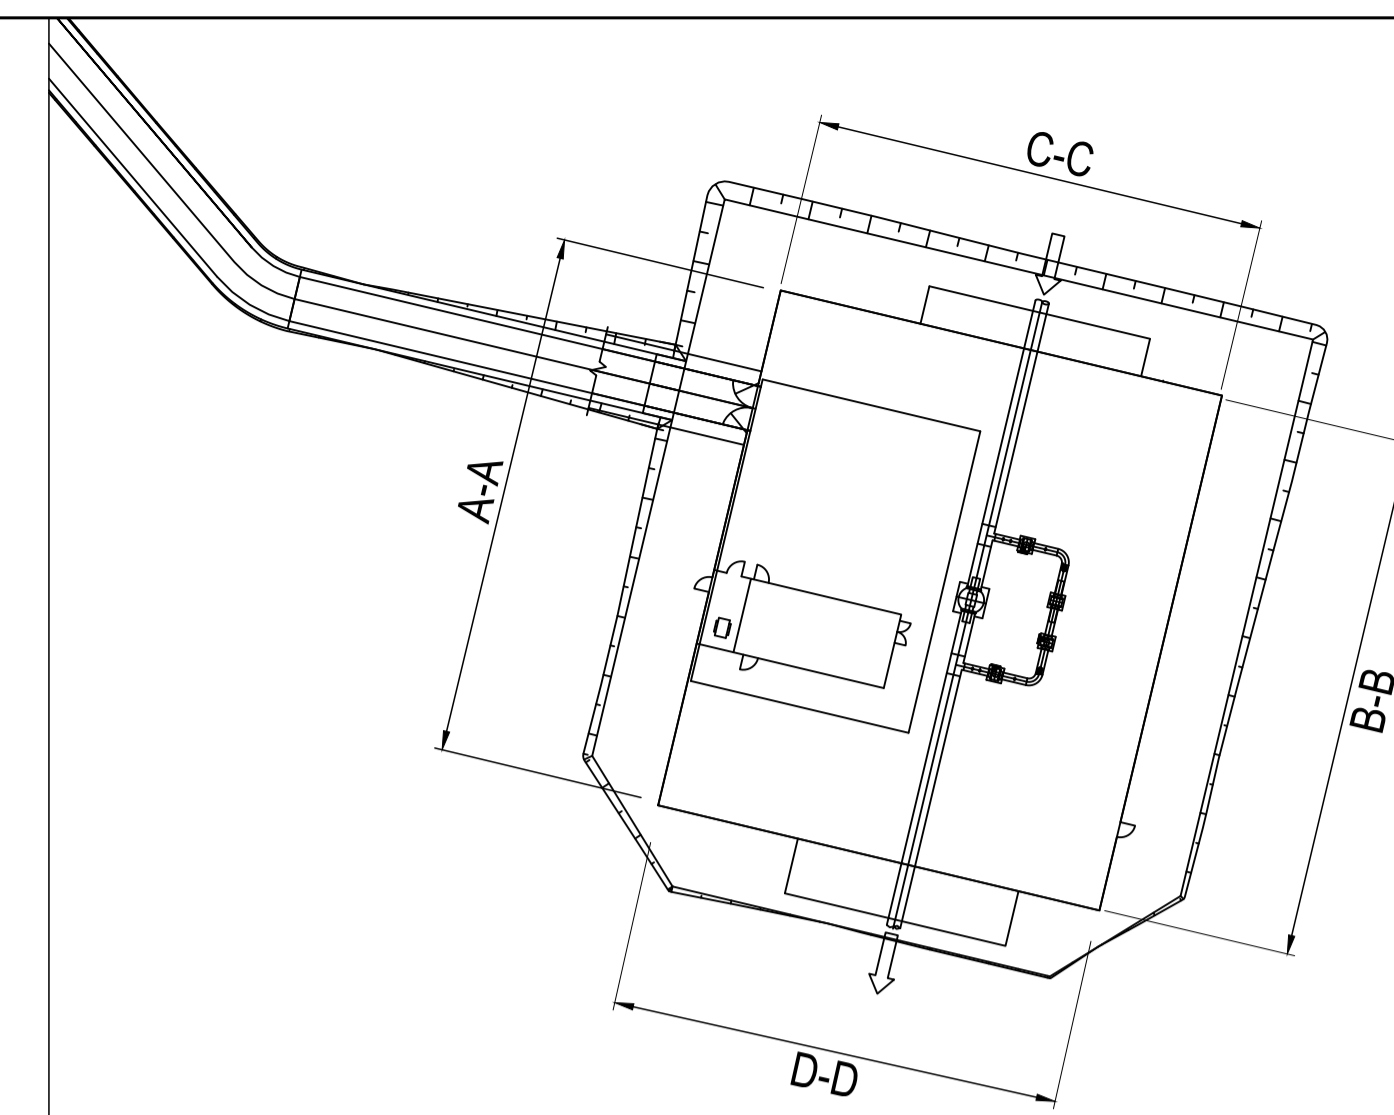

PLAN VIEW
(SCALE 1:500)
Pipeline and block valve are underground

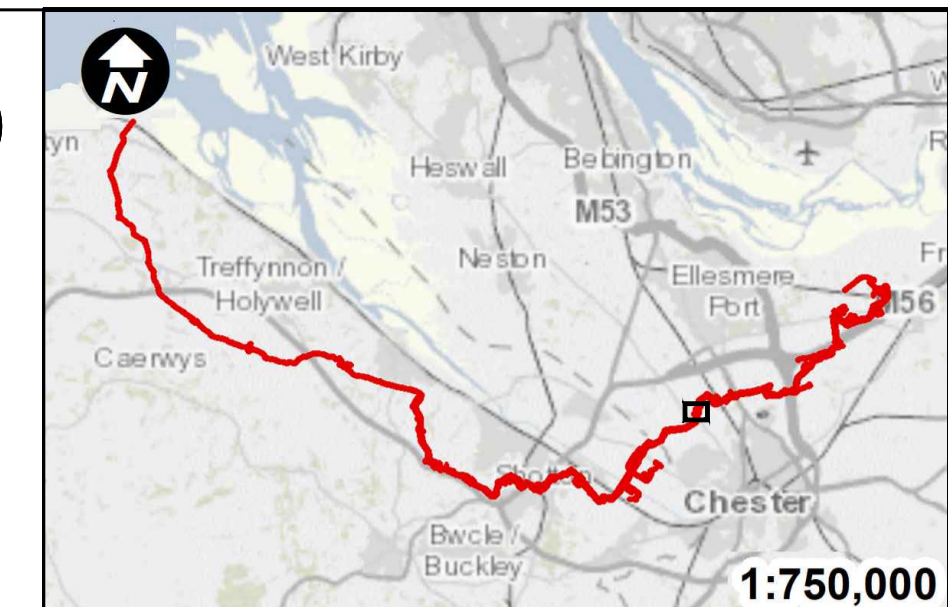

SCALE: 1:2500

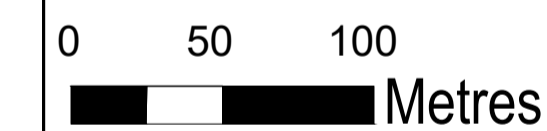

Contains OS data © Crown Copyright and database right 2020

HyNet North West

PROJECT TITLE
**HyNet Carbon Dioxide
Pipeline DCO**


DRAWING TITLE
MOLLINGTON BVS
ELEVATION PLAN
REGULATION 5(2)(o)
APPLICATION DOCUMENT REFERENCE D.2.8
SHEET 2 OF 6

DRAWING STATUS
FOR DESIGN CHANGE REQUEST 1


DRAWN TO	CHECKED JH	APPROVED VB	AUTHORISED AV
----------	------------	-------------	---------------

SCALE @ A1 SIZE 1:150	DATE 23/03/2023	REVISION B
--------------------------	--------------------	---------------


DRAWING NUMBER
EN070007-D.2.8-EL-Sheet 2

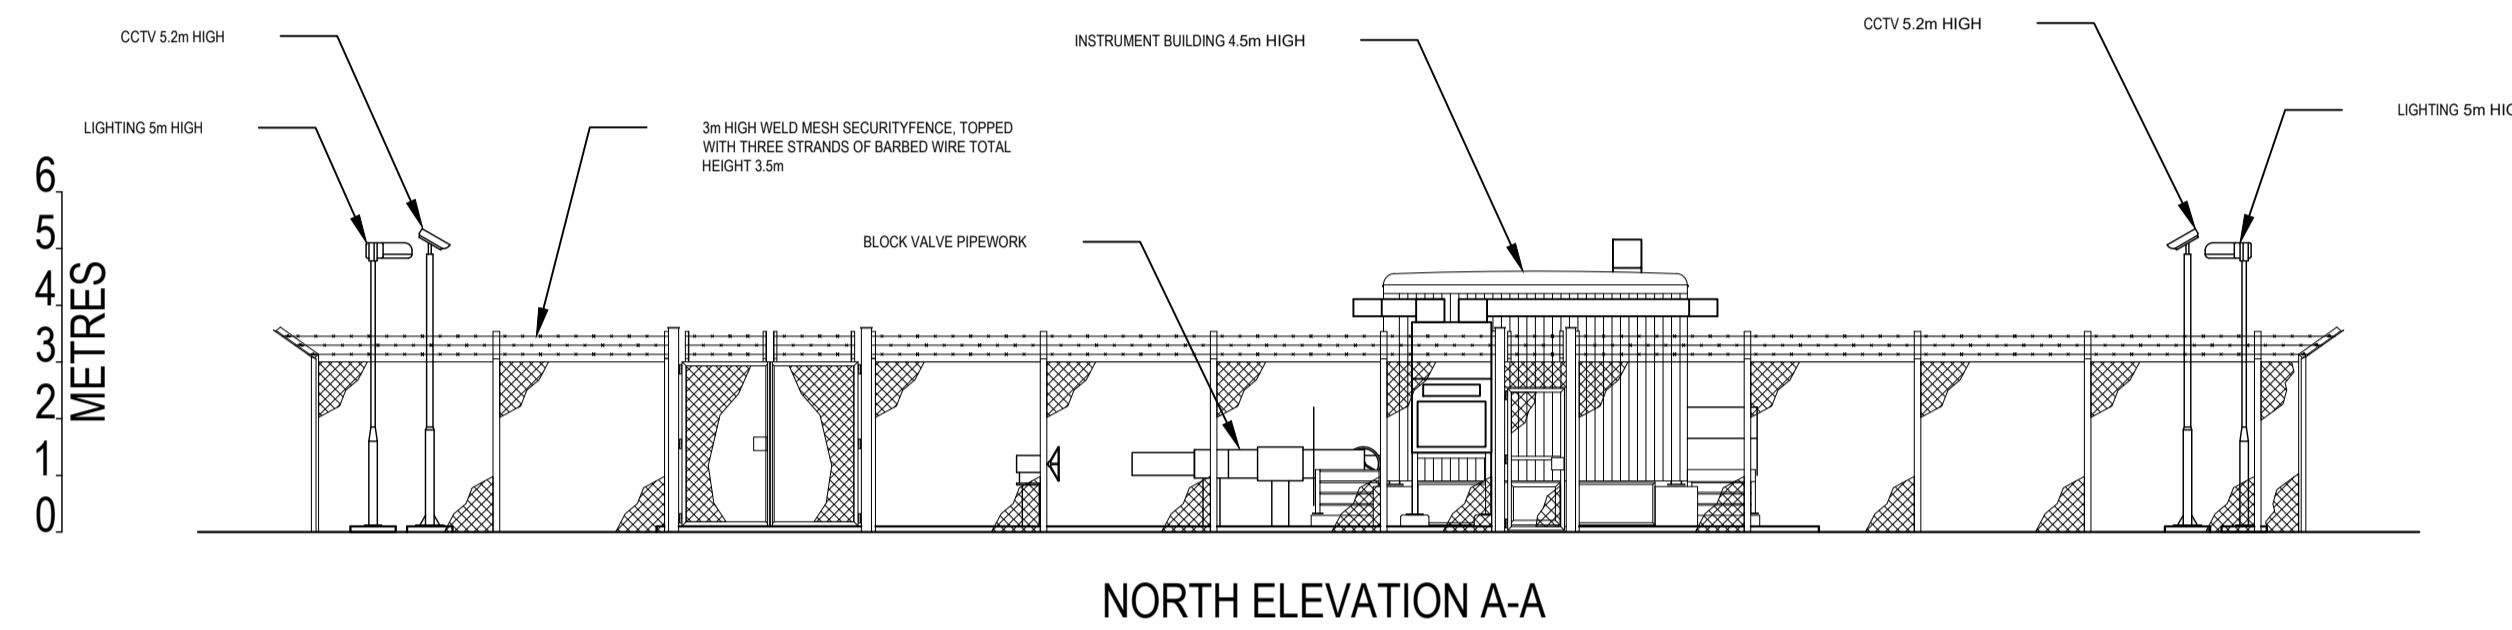


NORTH ELEVATION A-A

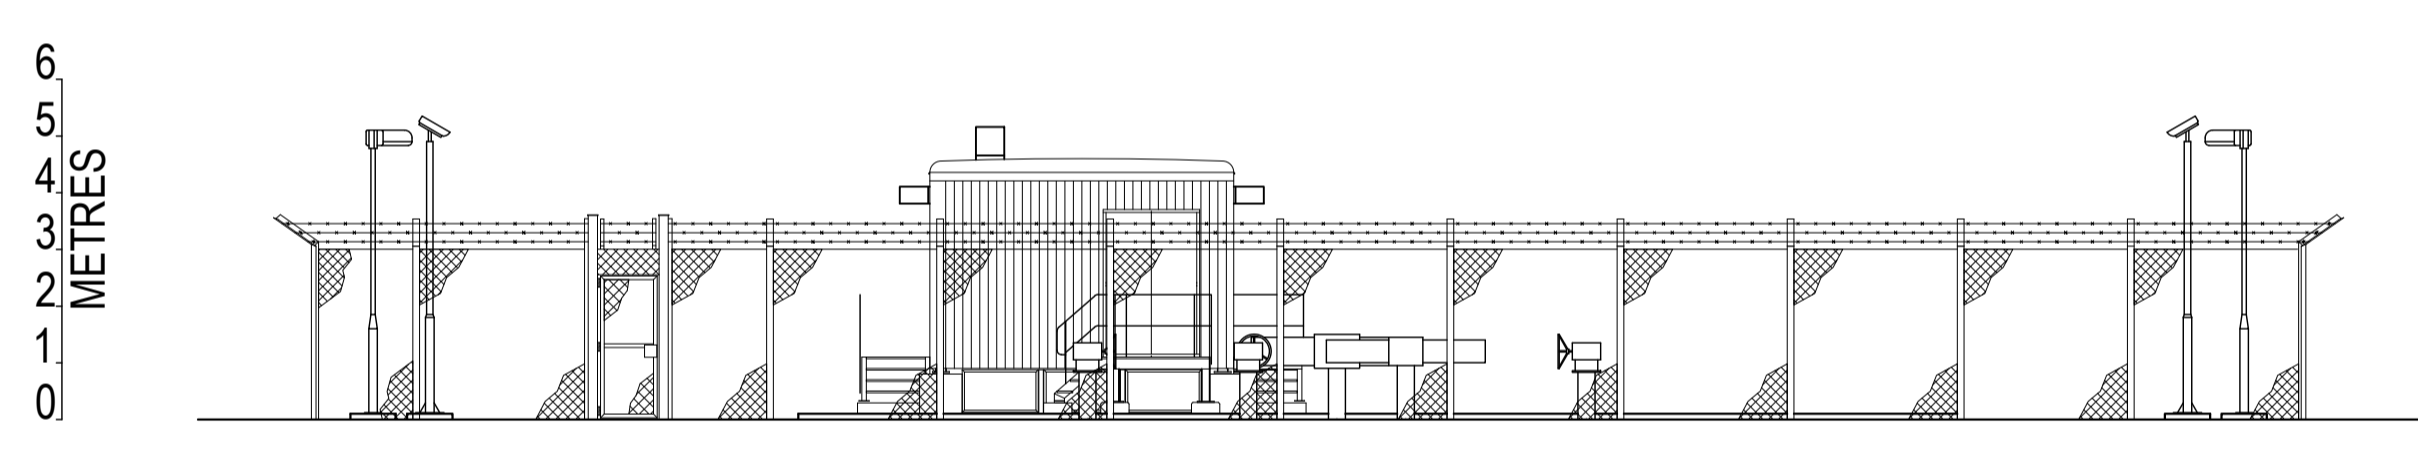


SOUTH ELEVATION B-B

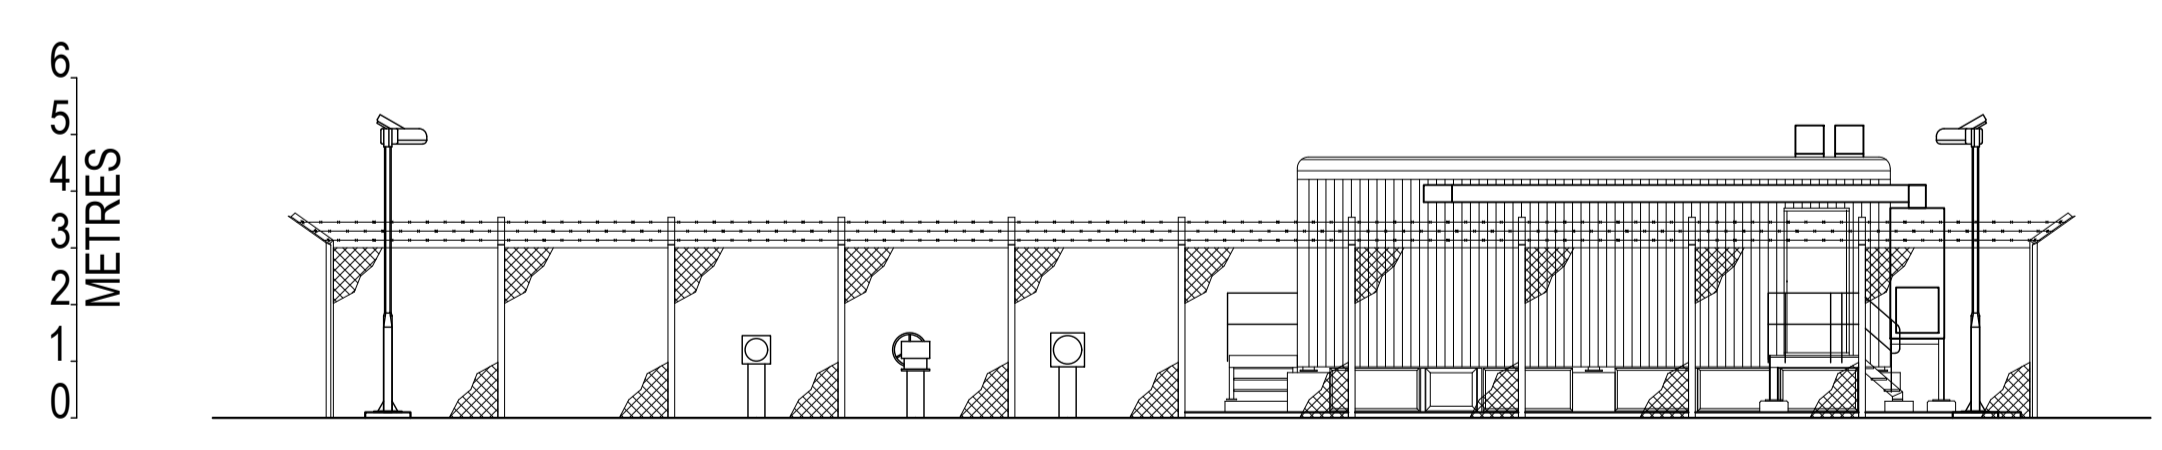


EAST ELEVATION C-C

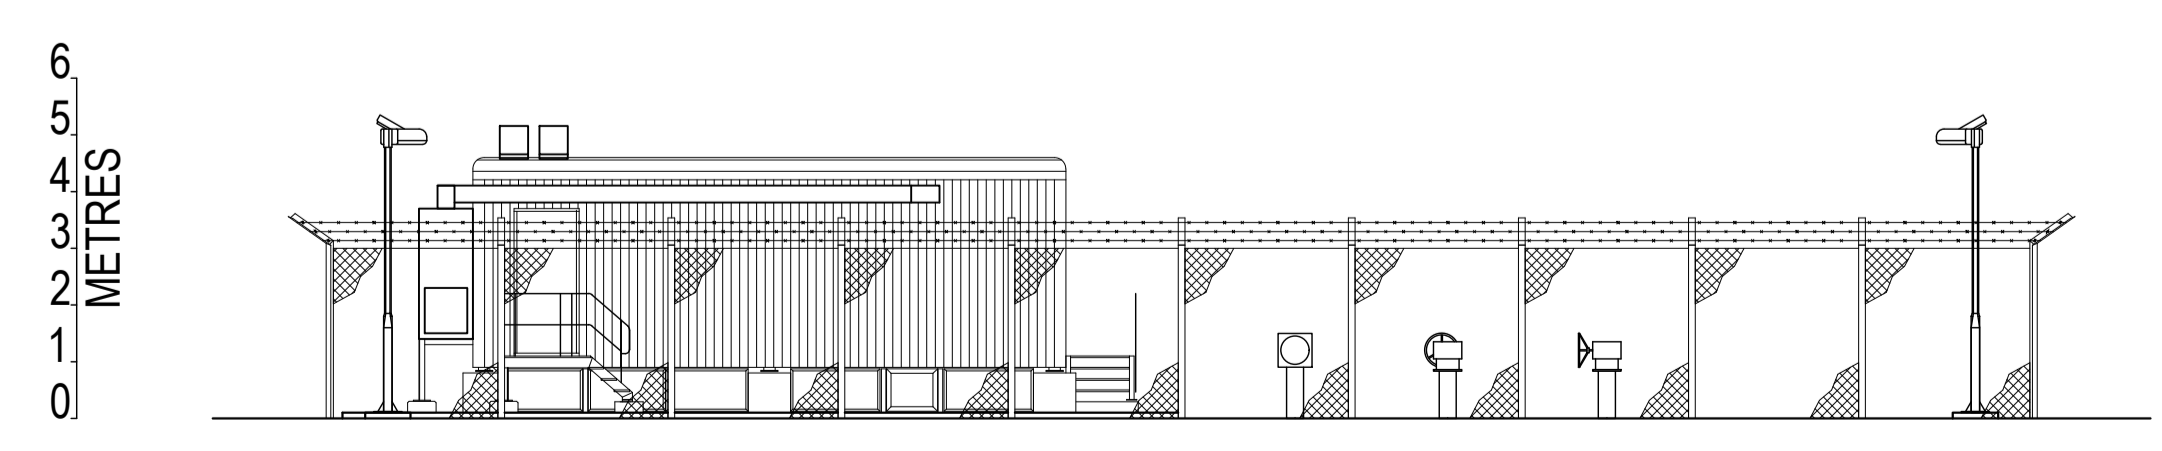


WEST ELEVATION D-D

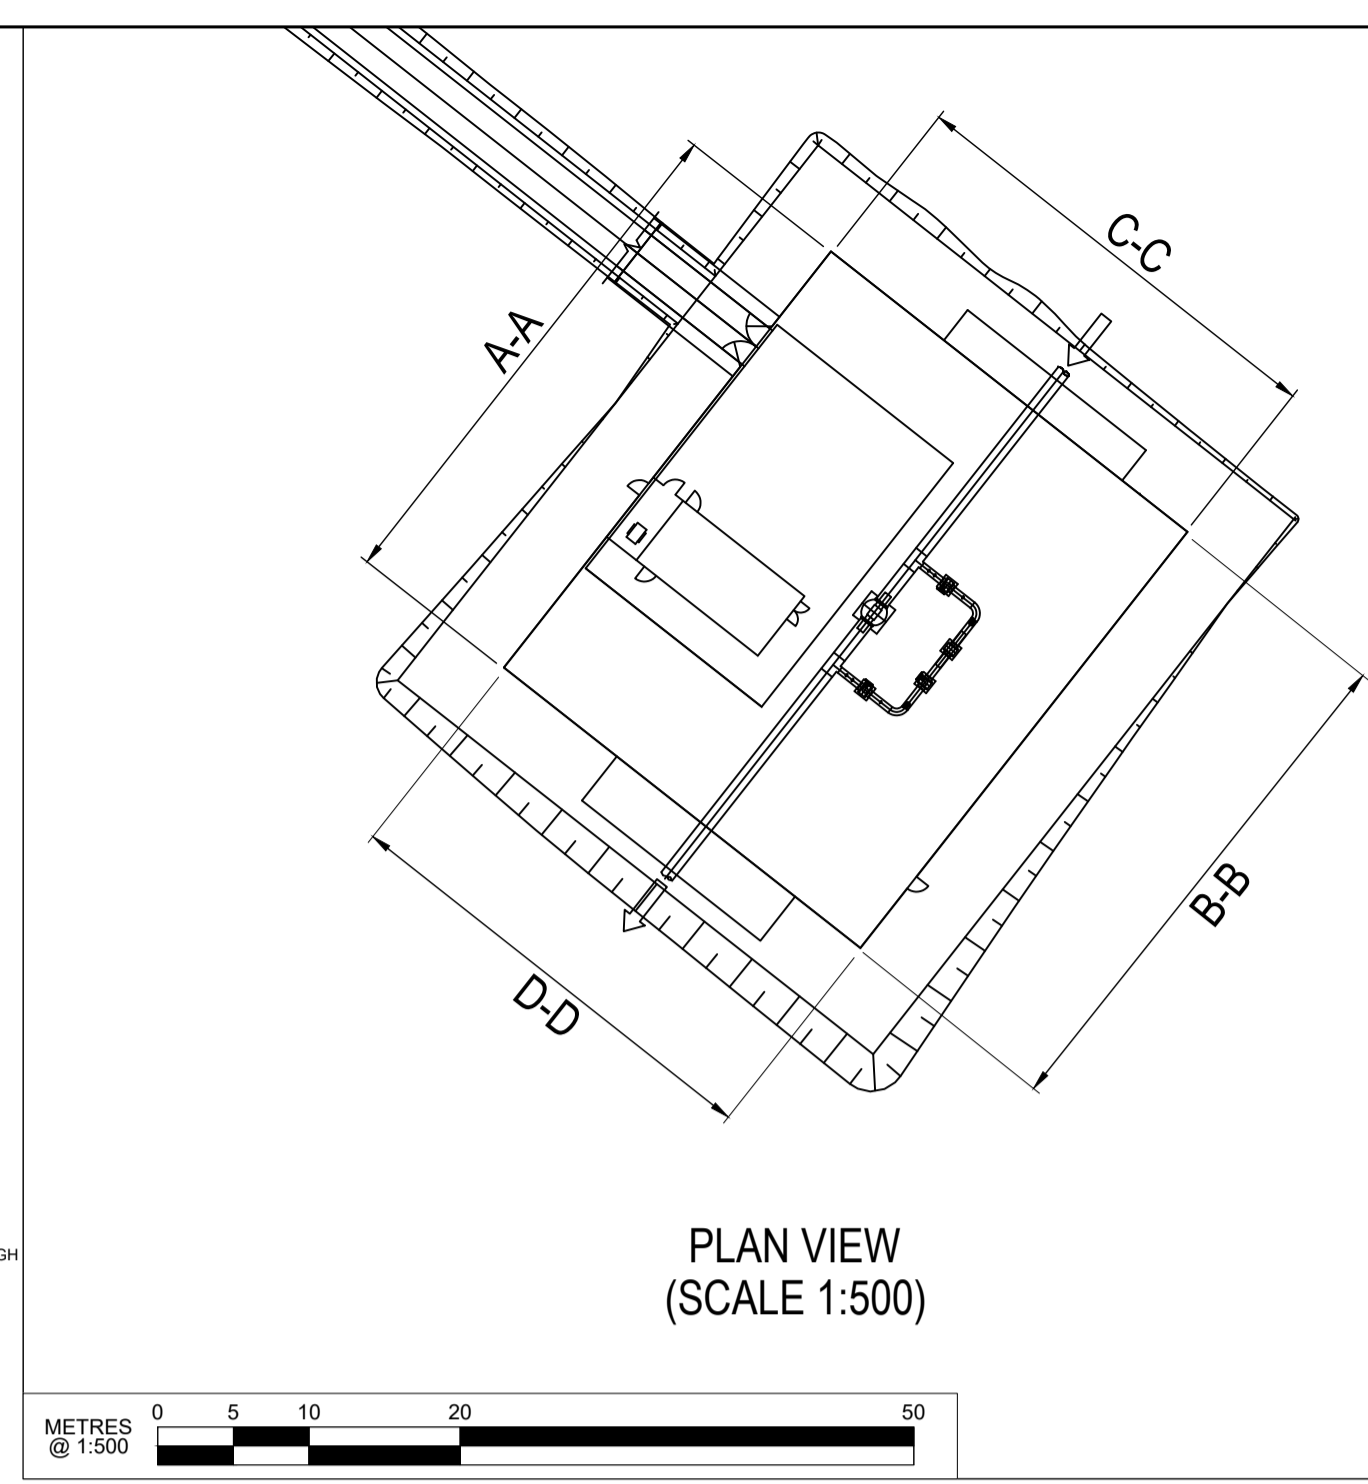

PLAN VIEW
(SCALE 1:500)

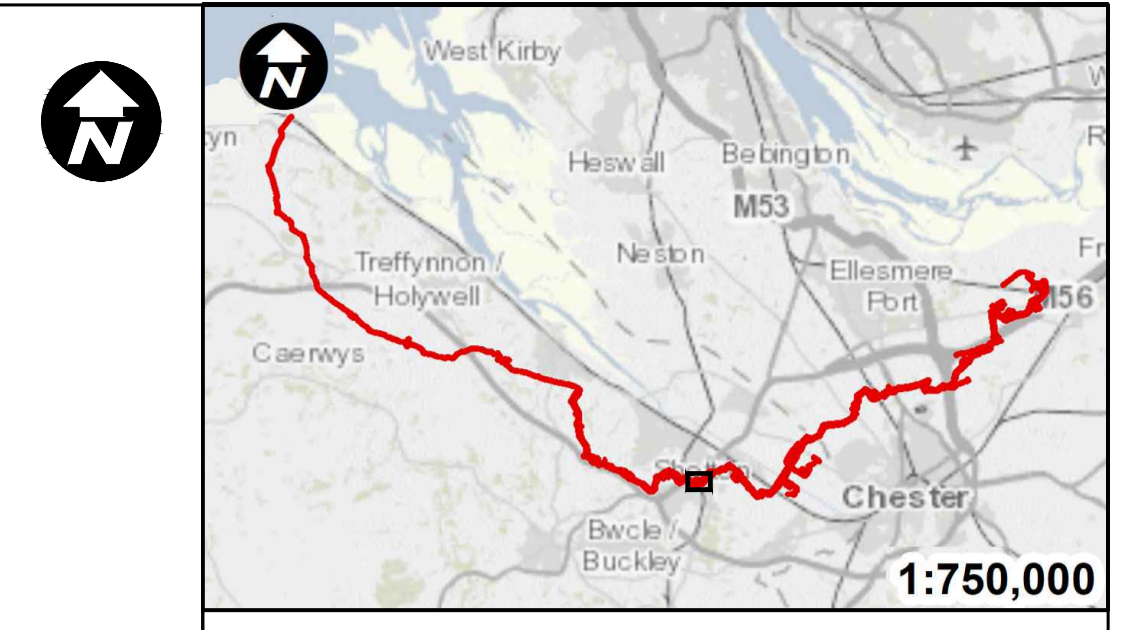

P01	TO	JH	VB	22/08/2022
REVISION	DRAWN	CHECKED	APPROVED	DATE

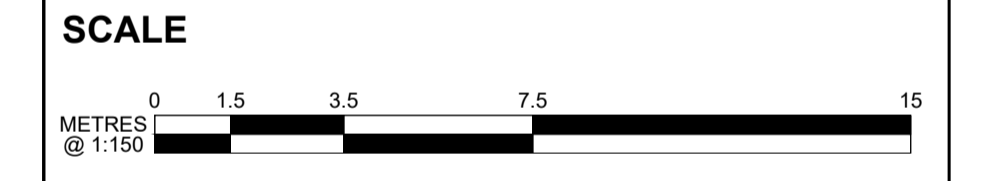

Mapping reproduced by permission of Ordnance Survey on behalf of HMSO
Contains OS data © Crown Copyright and database right 2022

HyNet North West


PROJECT TITLE
**HyNet
Carbon Dioxide Pipeline DCO**

DRAWING TITLE
ASTON HILL BVS
ELEVATION PLAN
REGULATION 5(2)(c)
APPLICATION DOCUMENT REFERENCE D.2.8
SHEET 3 OF 6


DRAWING STATUS
FOR DESIGN CHANGE REQUEST 1

DRAWN	CHECKED	APPROVED	AUTHORISED
TO	JH	VB	VB
SCALE @ A1 SIZE	DATE	REVISION	
1:150	23/03/2023	B	


DRAWING NUMBER
EN070007-D.2.8-EL-Sheet 3

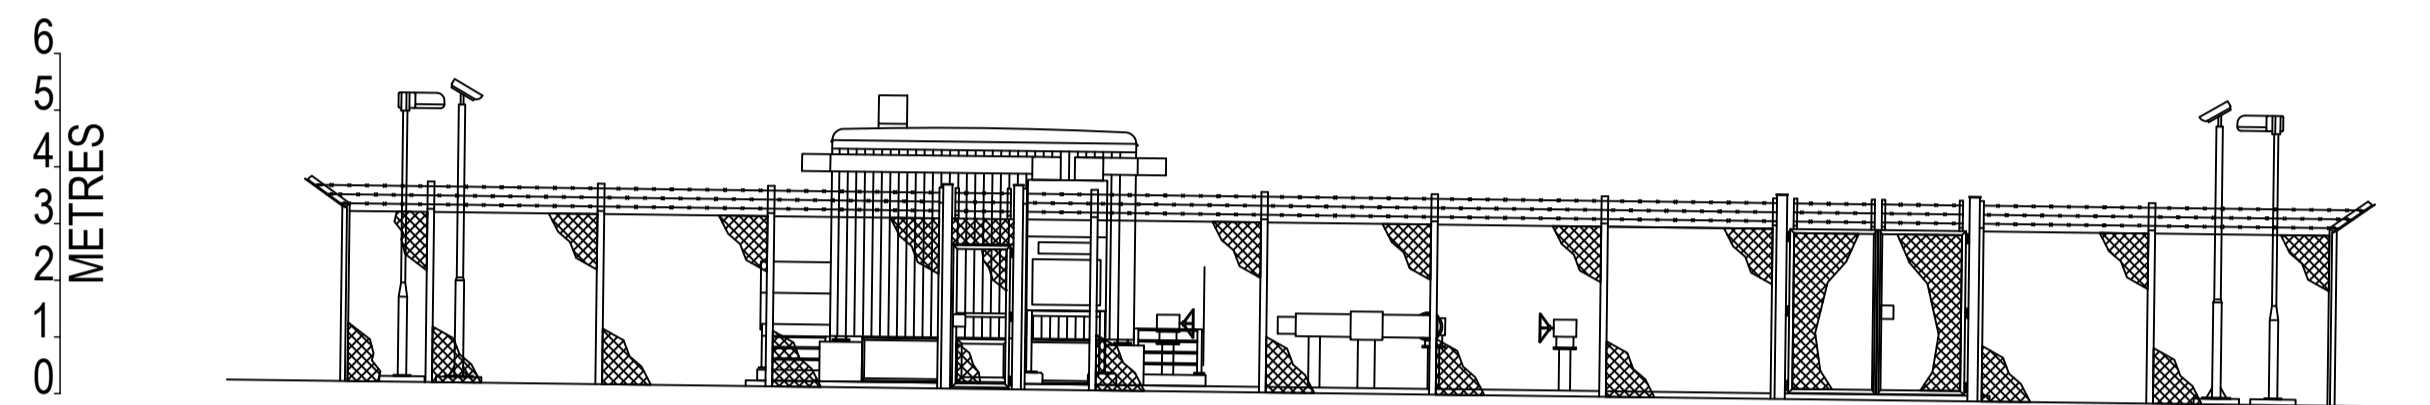


NORTH ELEVATION A-A

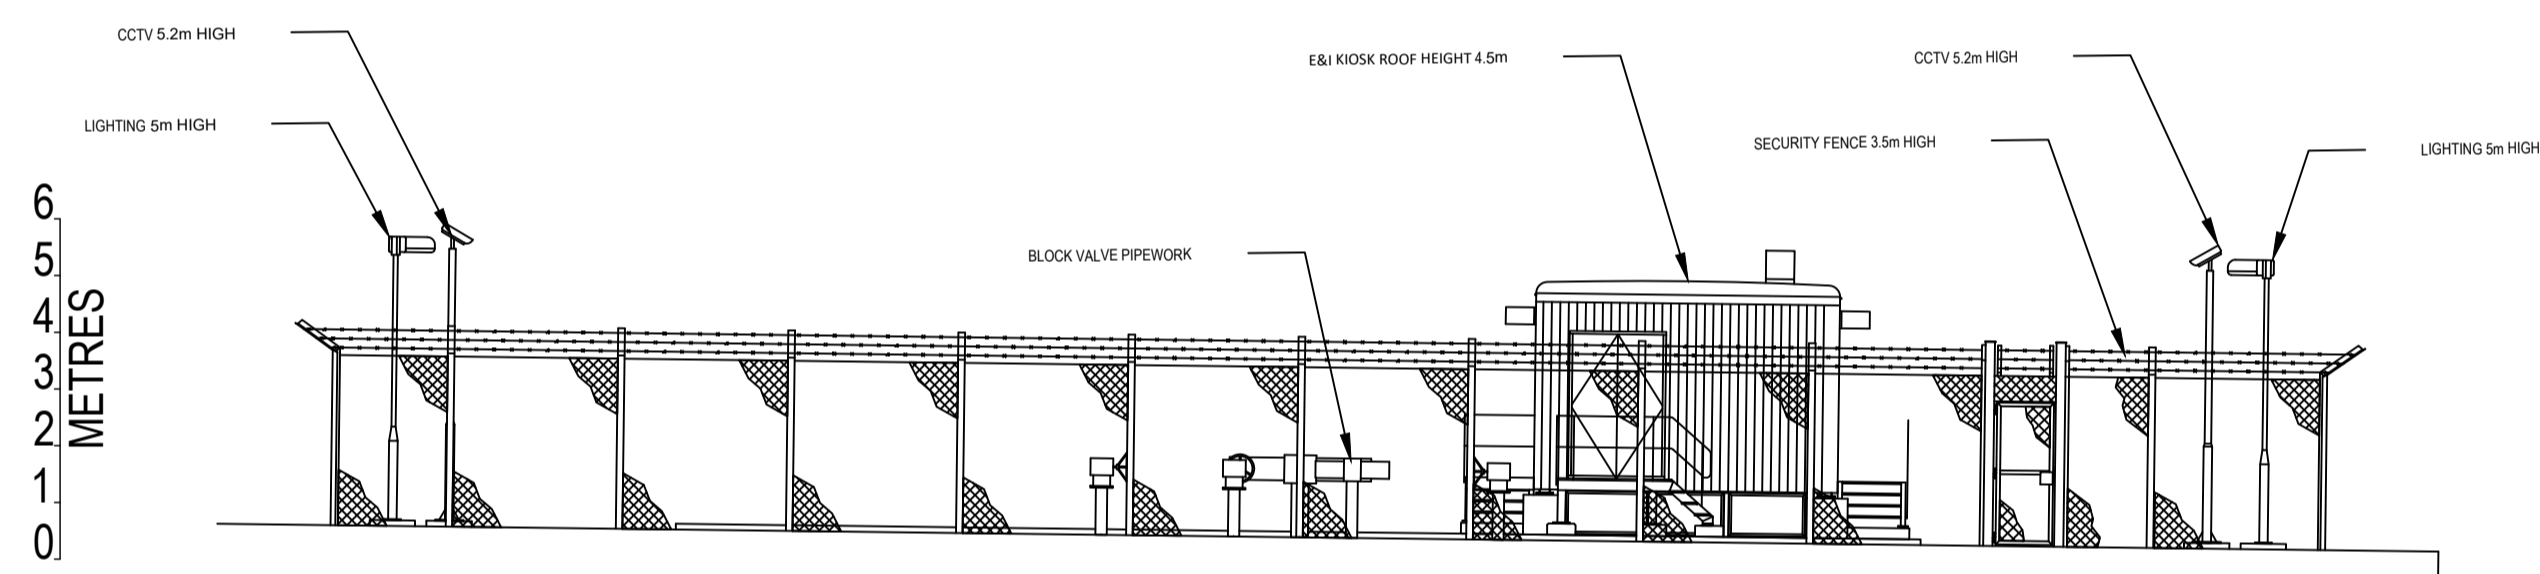



SOUTH ELEVATION B-B

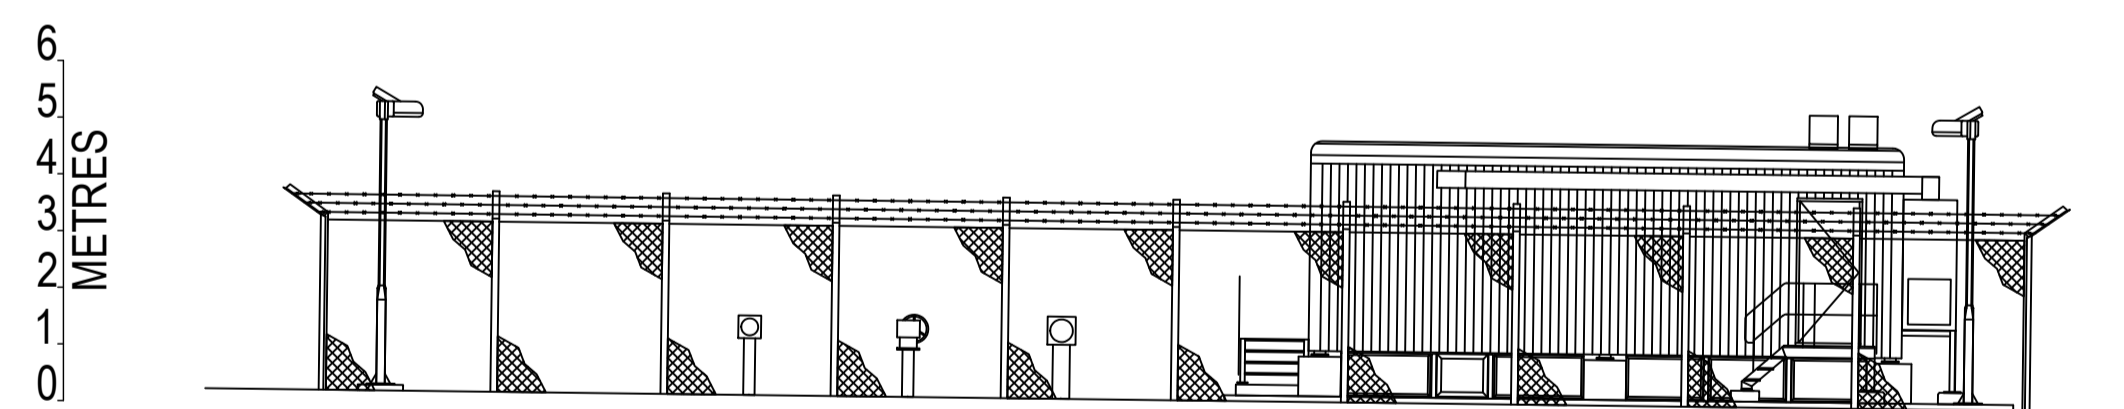

EAST ELEVATION C-C

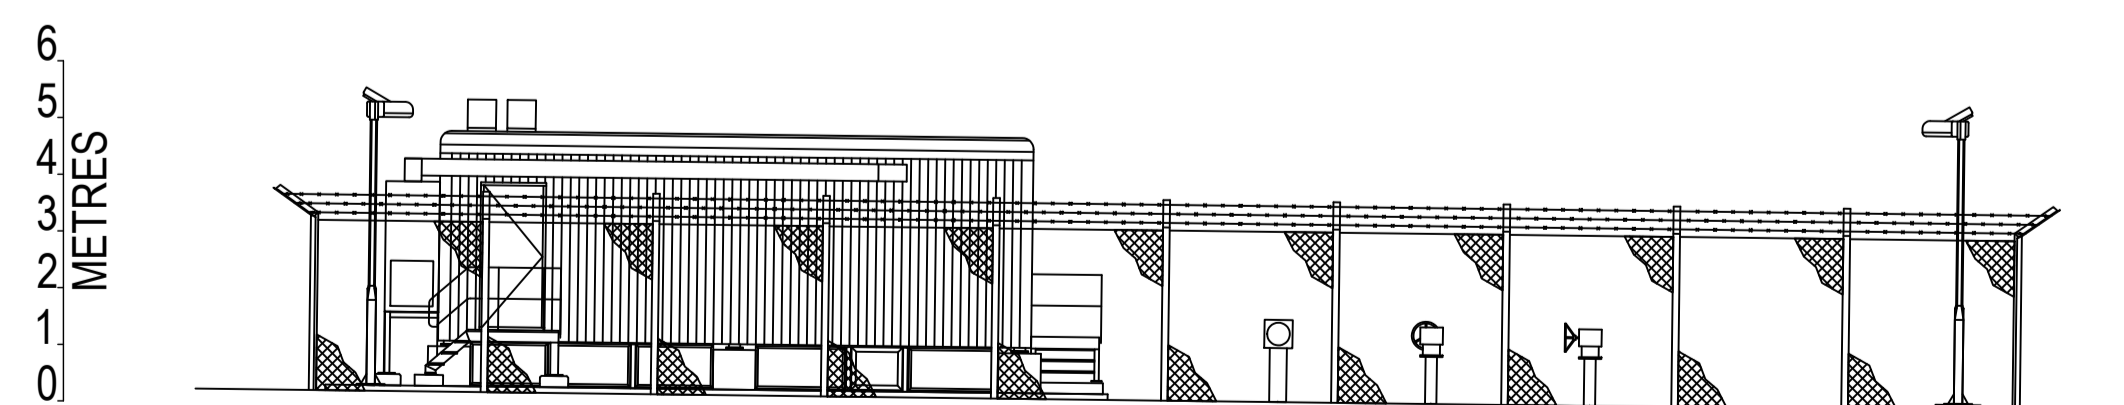


WEST ELEVATION D-D

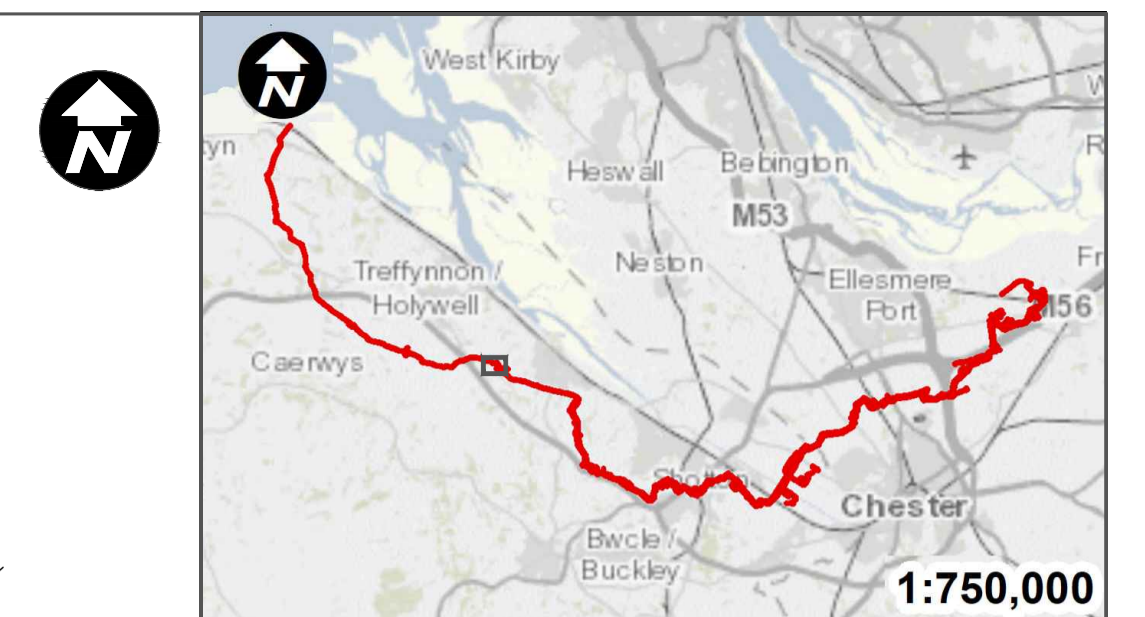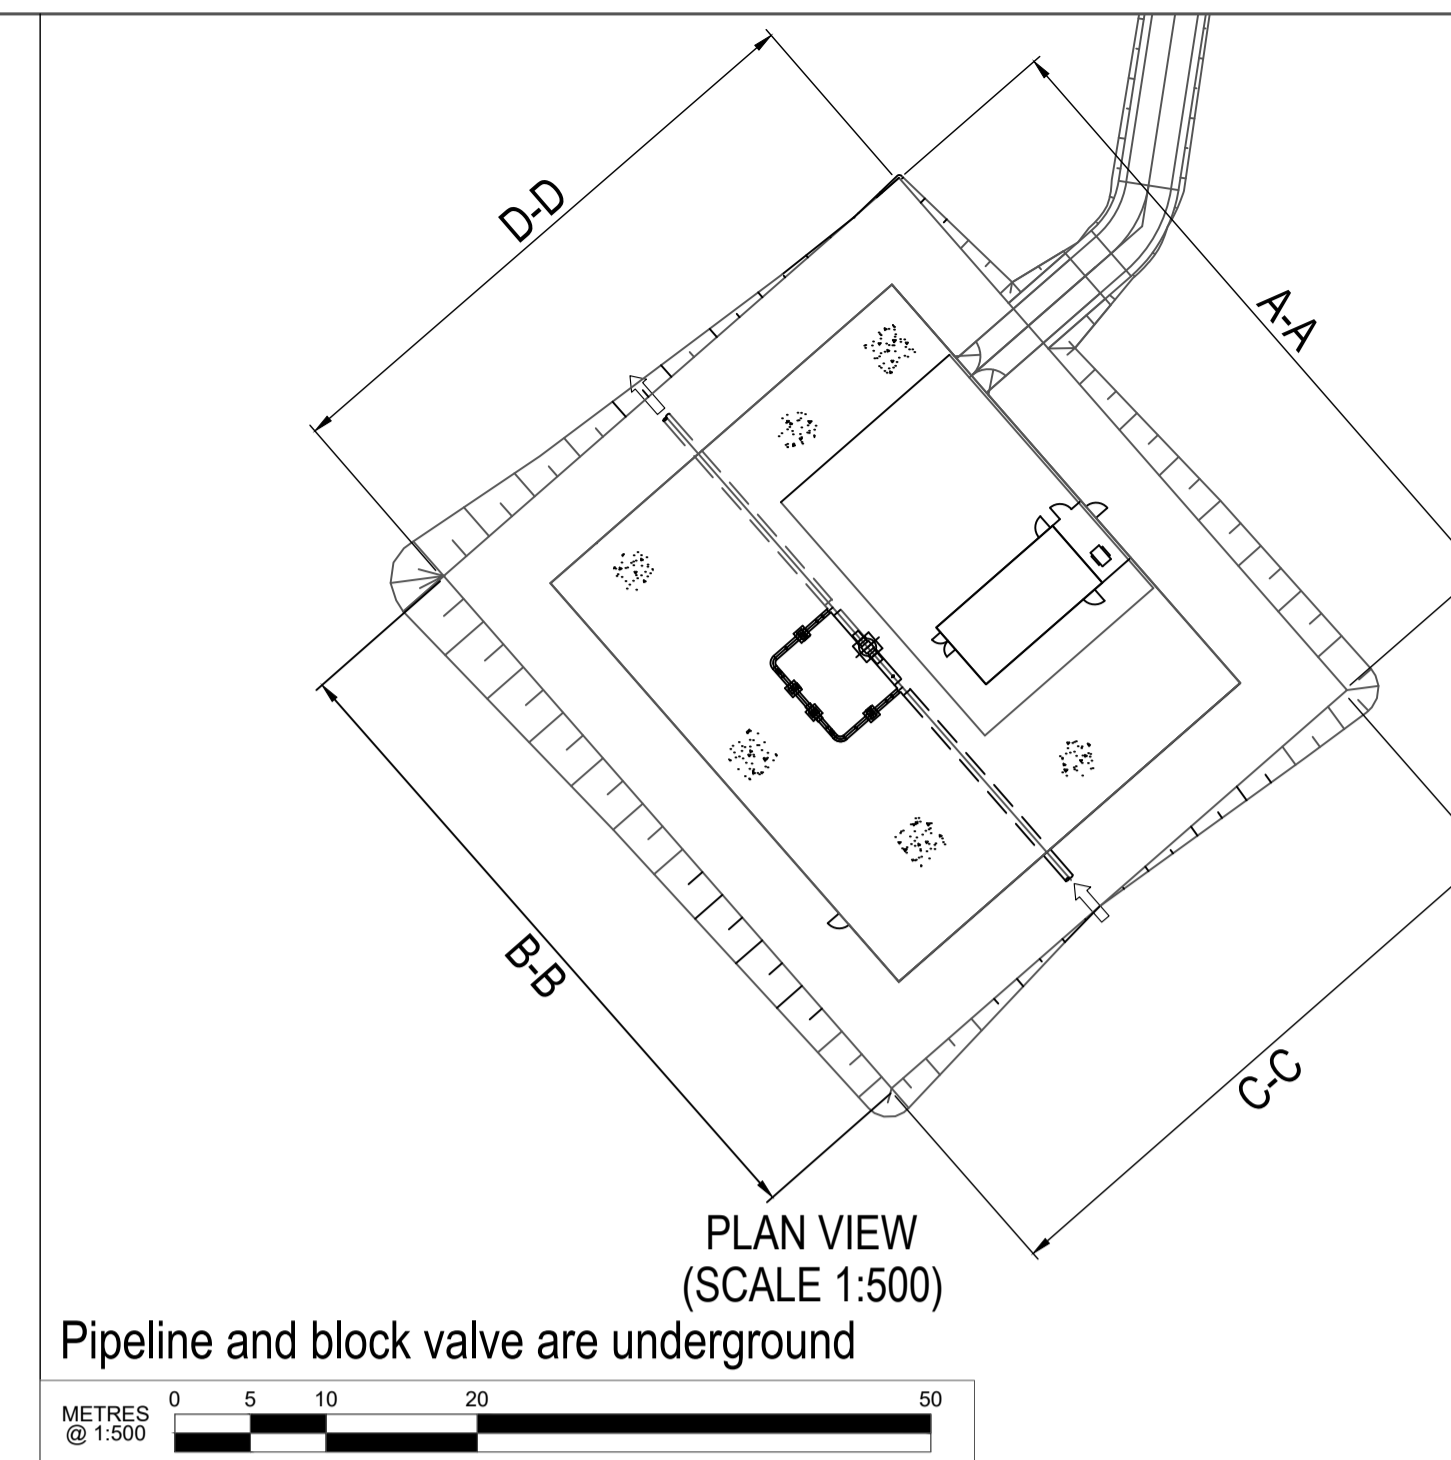

A	TO	JH	VB	27/09/2022
---	----	----	----	------------

REVISION	DRAWN	CHECKED	APPROVED	DATE
----------	-------	---------	----------	------

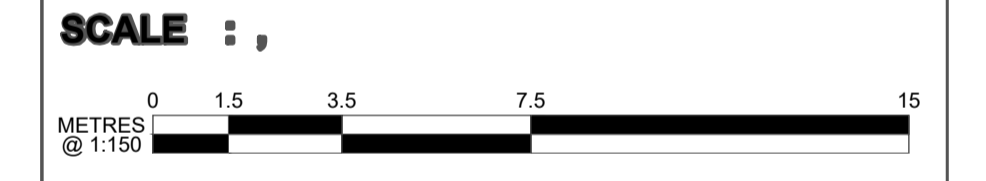

Contains OS data © Crown Copyright and database right 2020



PROJECT TITLE
HyNet Carbon Dioxide Pipeline DCO


DRAWING TITLE
CORNIST LANE BVS
ELEVATION PLAN
REGULATION 5(2)(o)
APPLICATION DOCUMENT REFERENCE D.2.8
SHEET 4 OF 6

DRAWING STATUS
FOR DESIGN CHANGE REQUEST 1


DRAWN TO	CHECKED JH	APPROVED VB	AUTHORISED AV
----------	------------	-------------	---------------

SCALE @ A1 SIZE 1:150	DATE 23/03/2023	REVISION B
--------------------------	--------------------	---------------


DRAWING NUMBER
EN070007-D.2.8-EL-Sheet 4

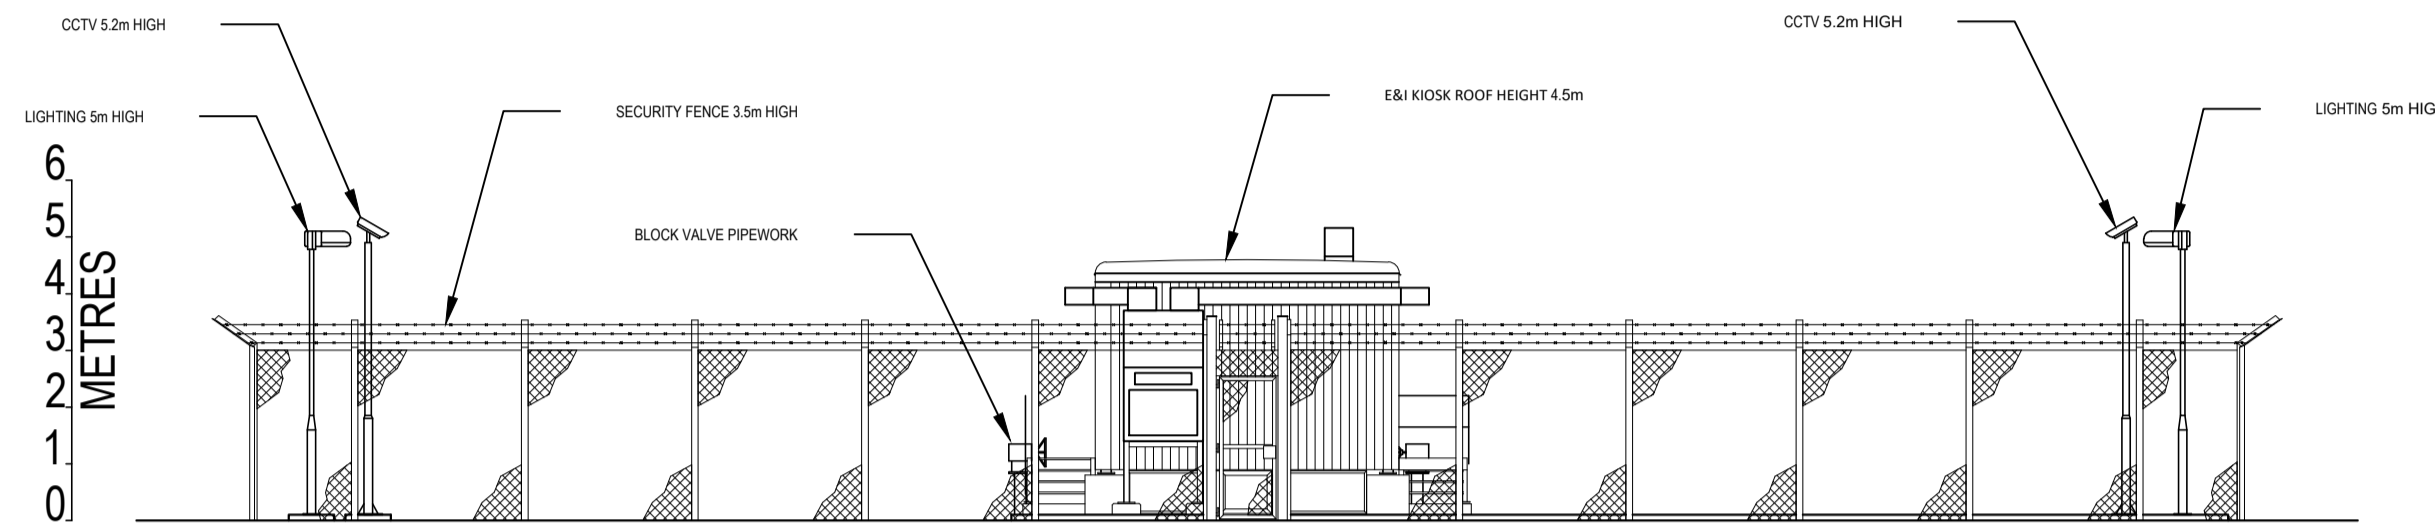


NORTH ELEVATION A-A

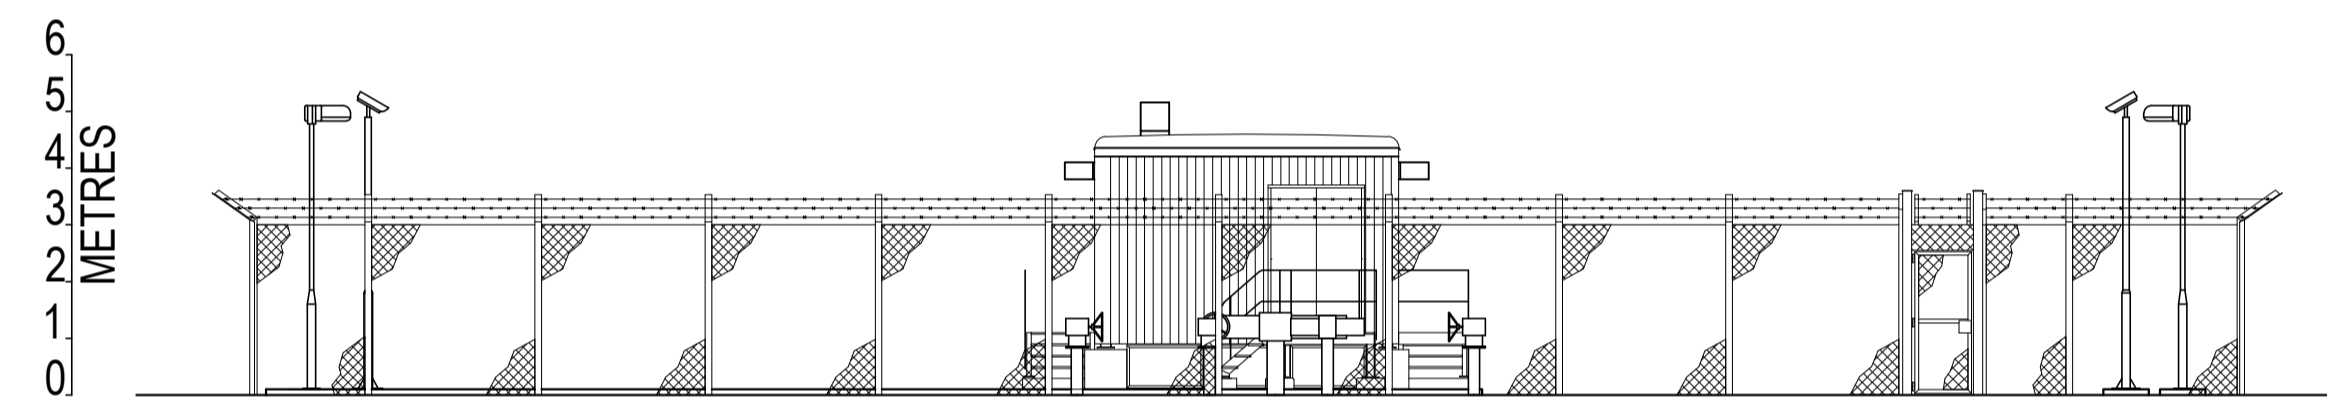


SOUTH ELEVATION B-B

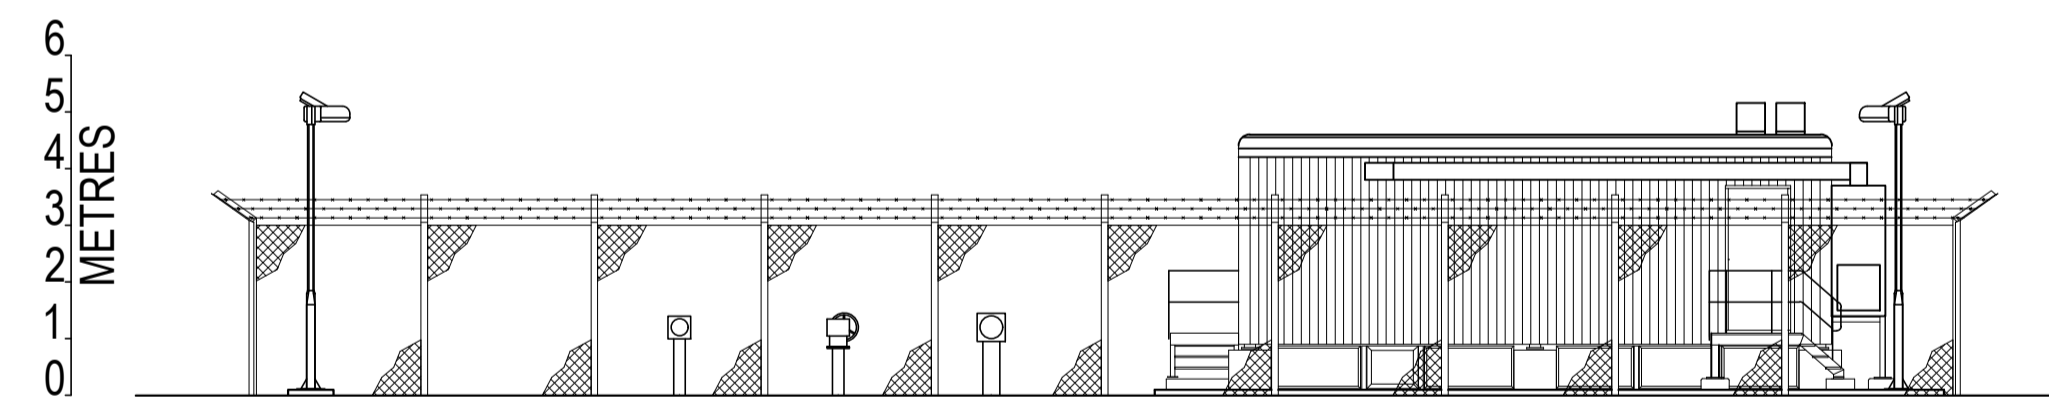


EAST ELEVATION C-C

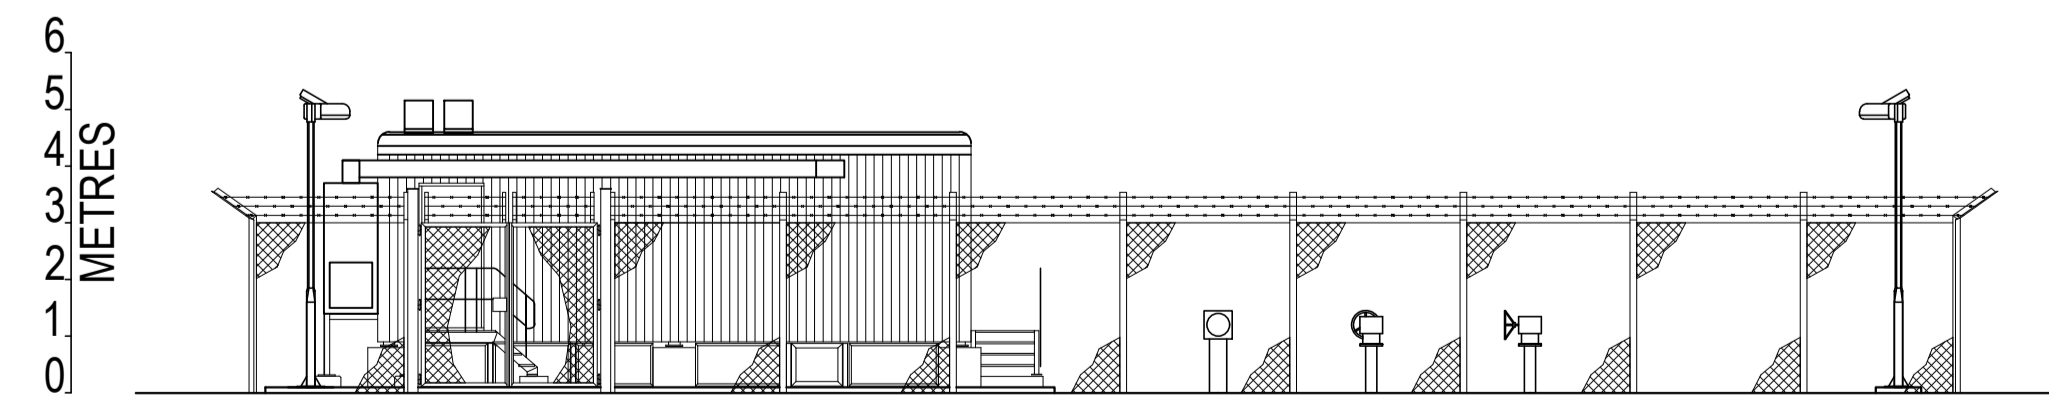


WEST ELEVATION D-D

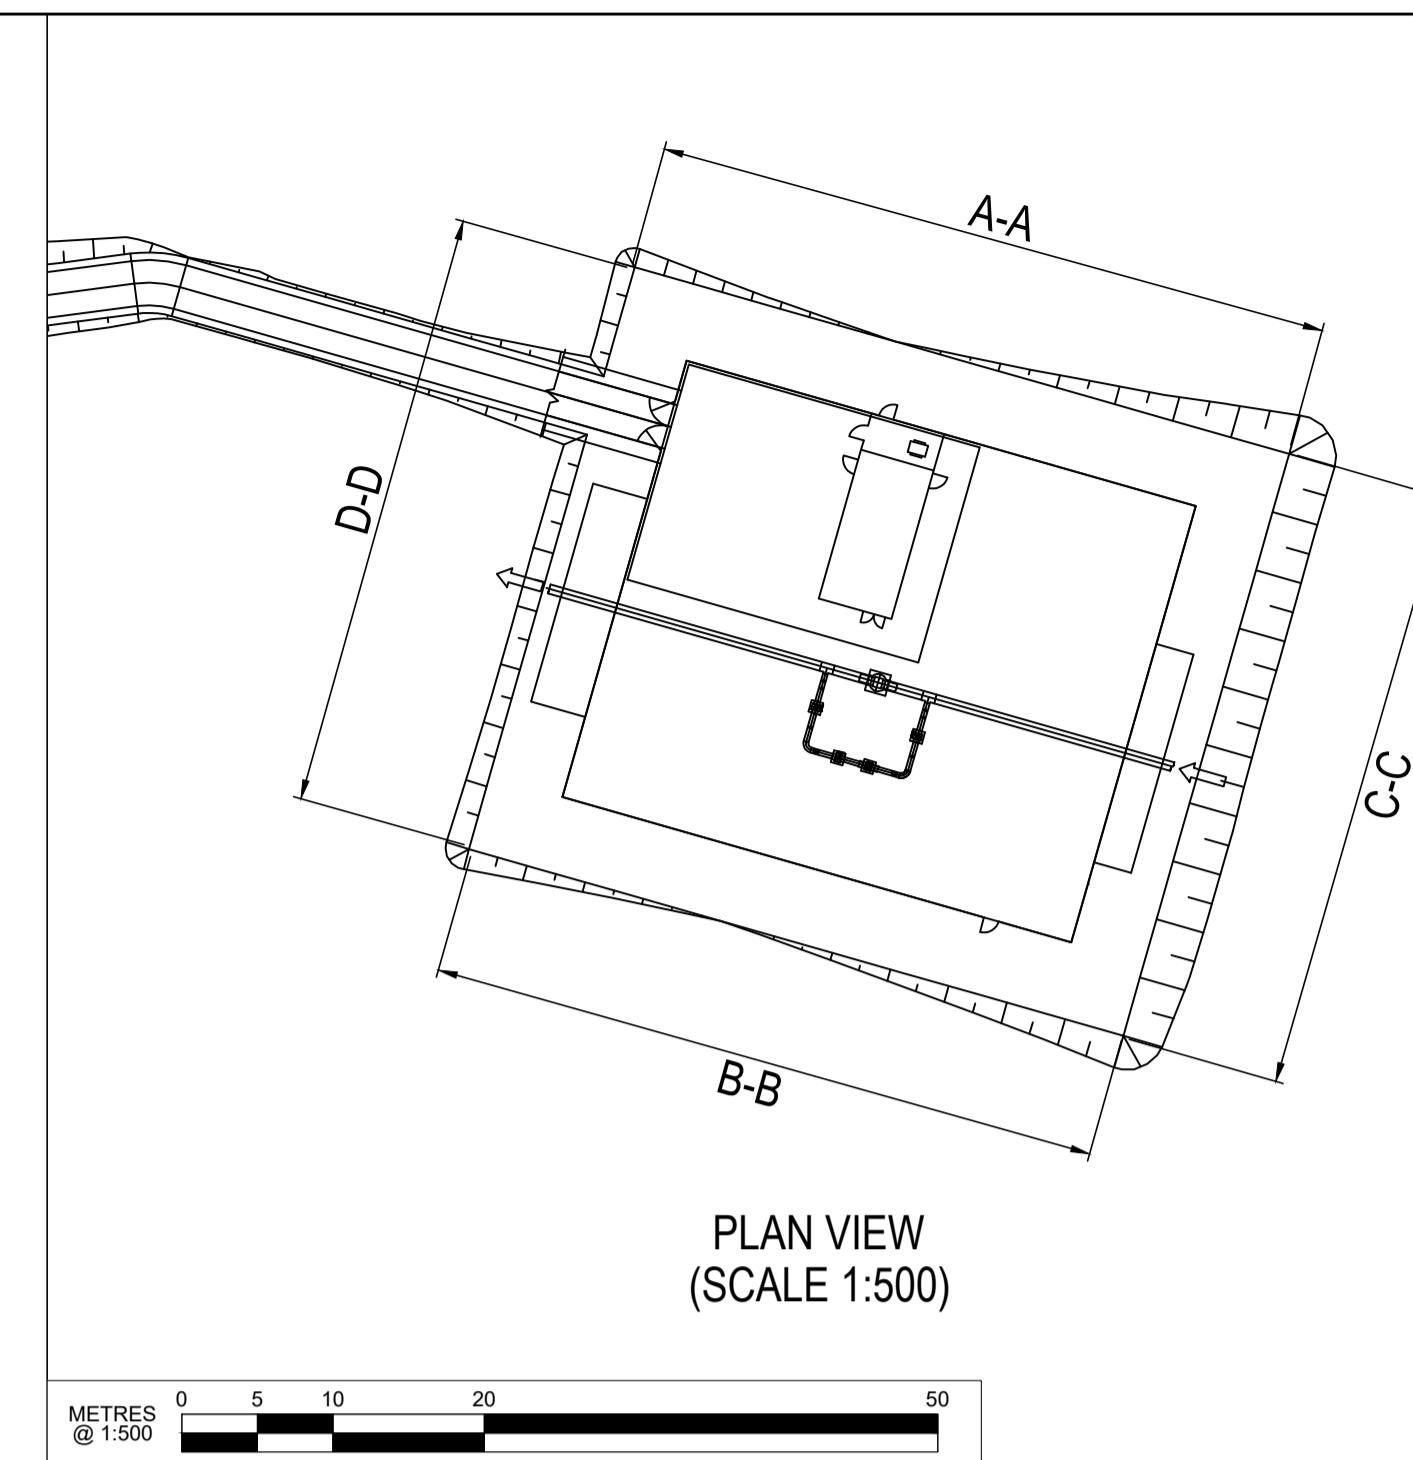

PLAN VIEW
(SCALE 1:500)

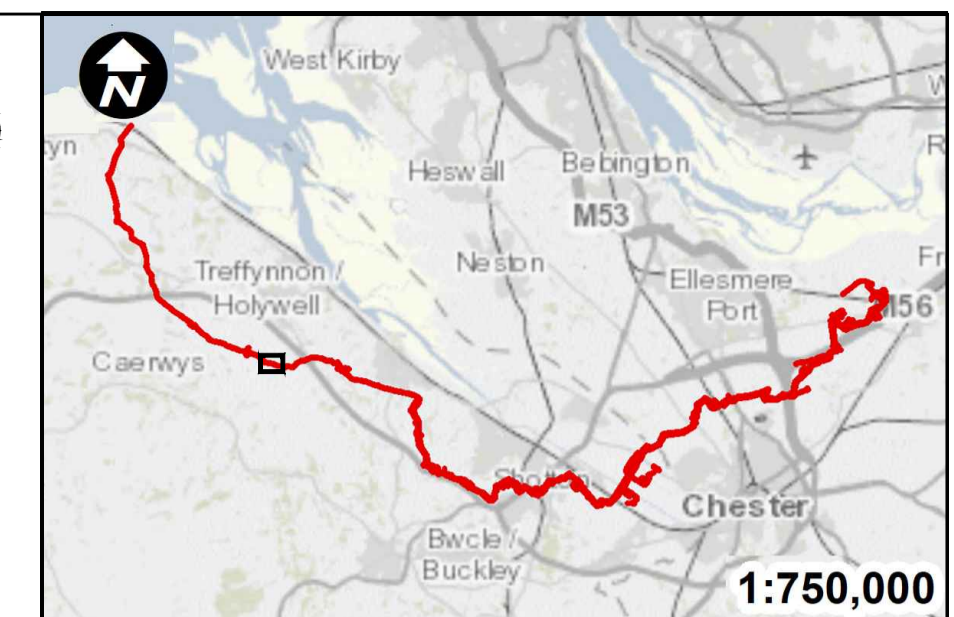

SCALE: 1:2500

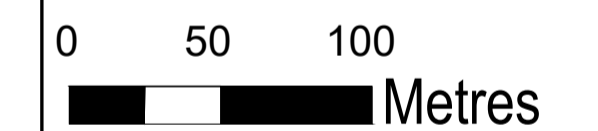

Contains OS data © Crown Copyright and database right 2020

HyNet North West

PROJECT TITLE
HyNet Carbon Dioxide Pipeline DCO


DRAWING TITLE
PENTRE HALKYN BVS
ELEVATION PLAN
REGULATION 5(2)(o)
APPLICATION DOCUMENT REFERENCE D.2.8
SHEET 5 OF 6

DRAWING STATUS
FOR DESIGN CHANGE REQUEST 1


DRAWN TO	CHECKED JH	APPROVED VB	AUTHORISED AV
----------	------------	-------------	---------------

SCALE @ A1 SIZE 1:150	DATE 23/03/2023	REVISION B
--------------------------	--------------------	---------------


DRAWING NUMBER
EN070007-D.2.8-EL-Sheet 5

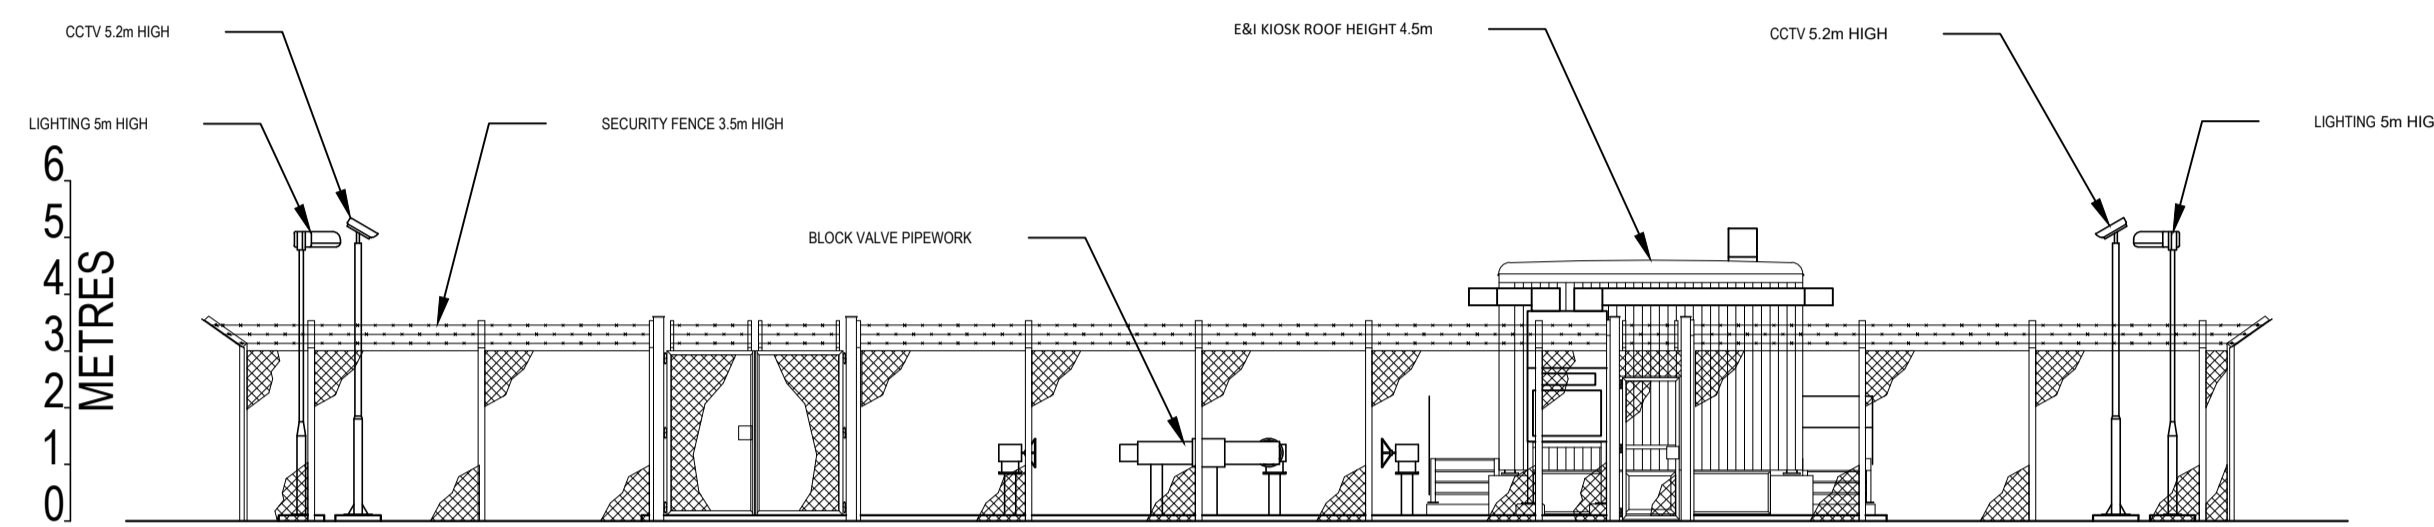


NORTH ELEVATION A-A

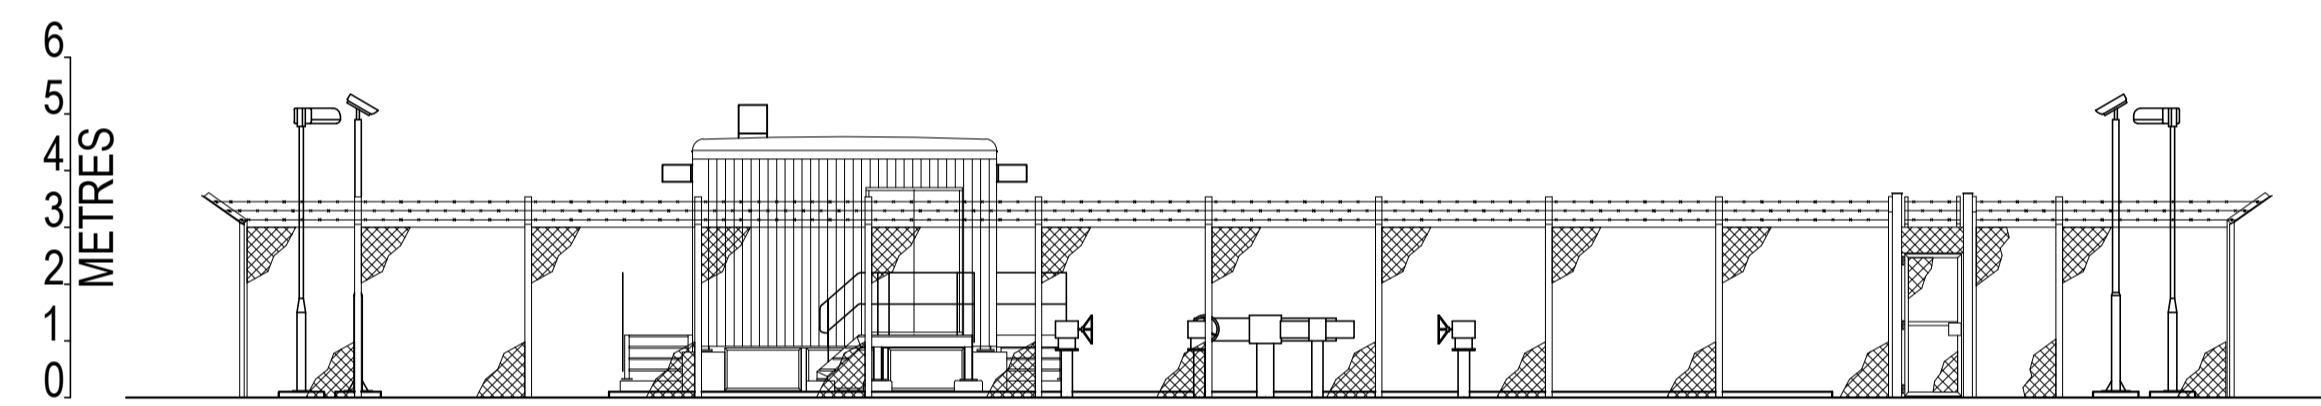


SOUTH ELEVATION B-B

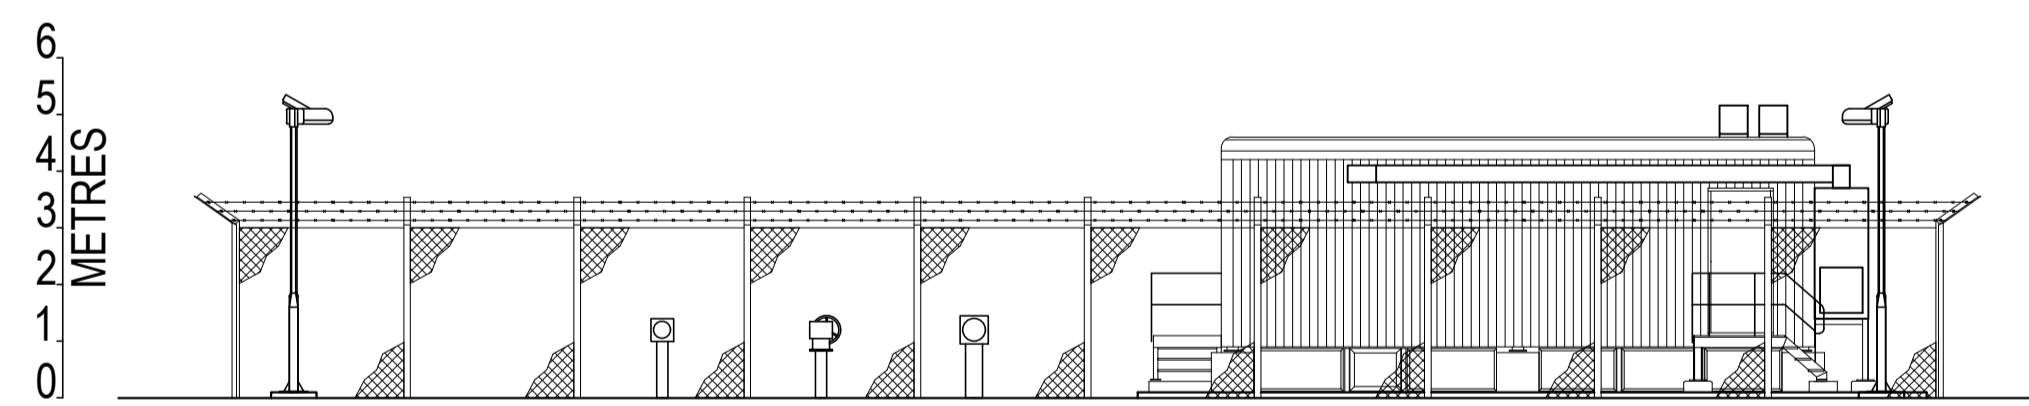


EAST ELEVATION C-C

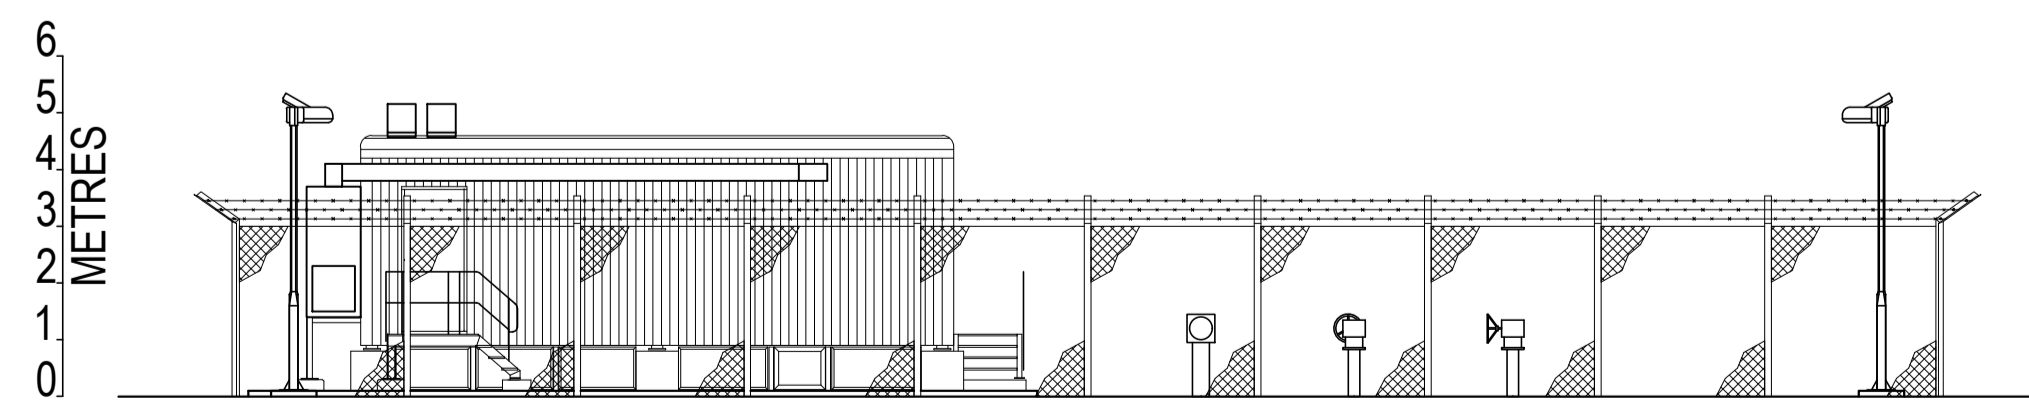

WEST ELEVATION D-D

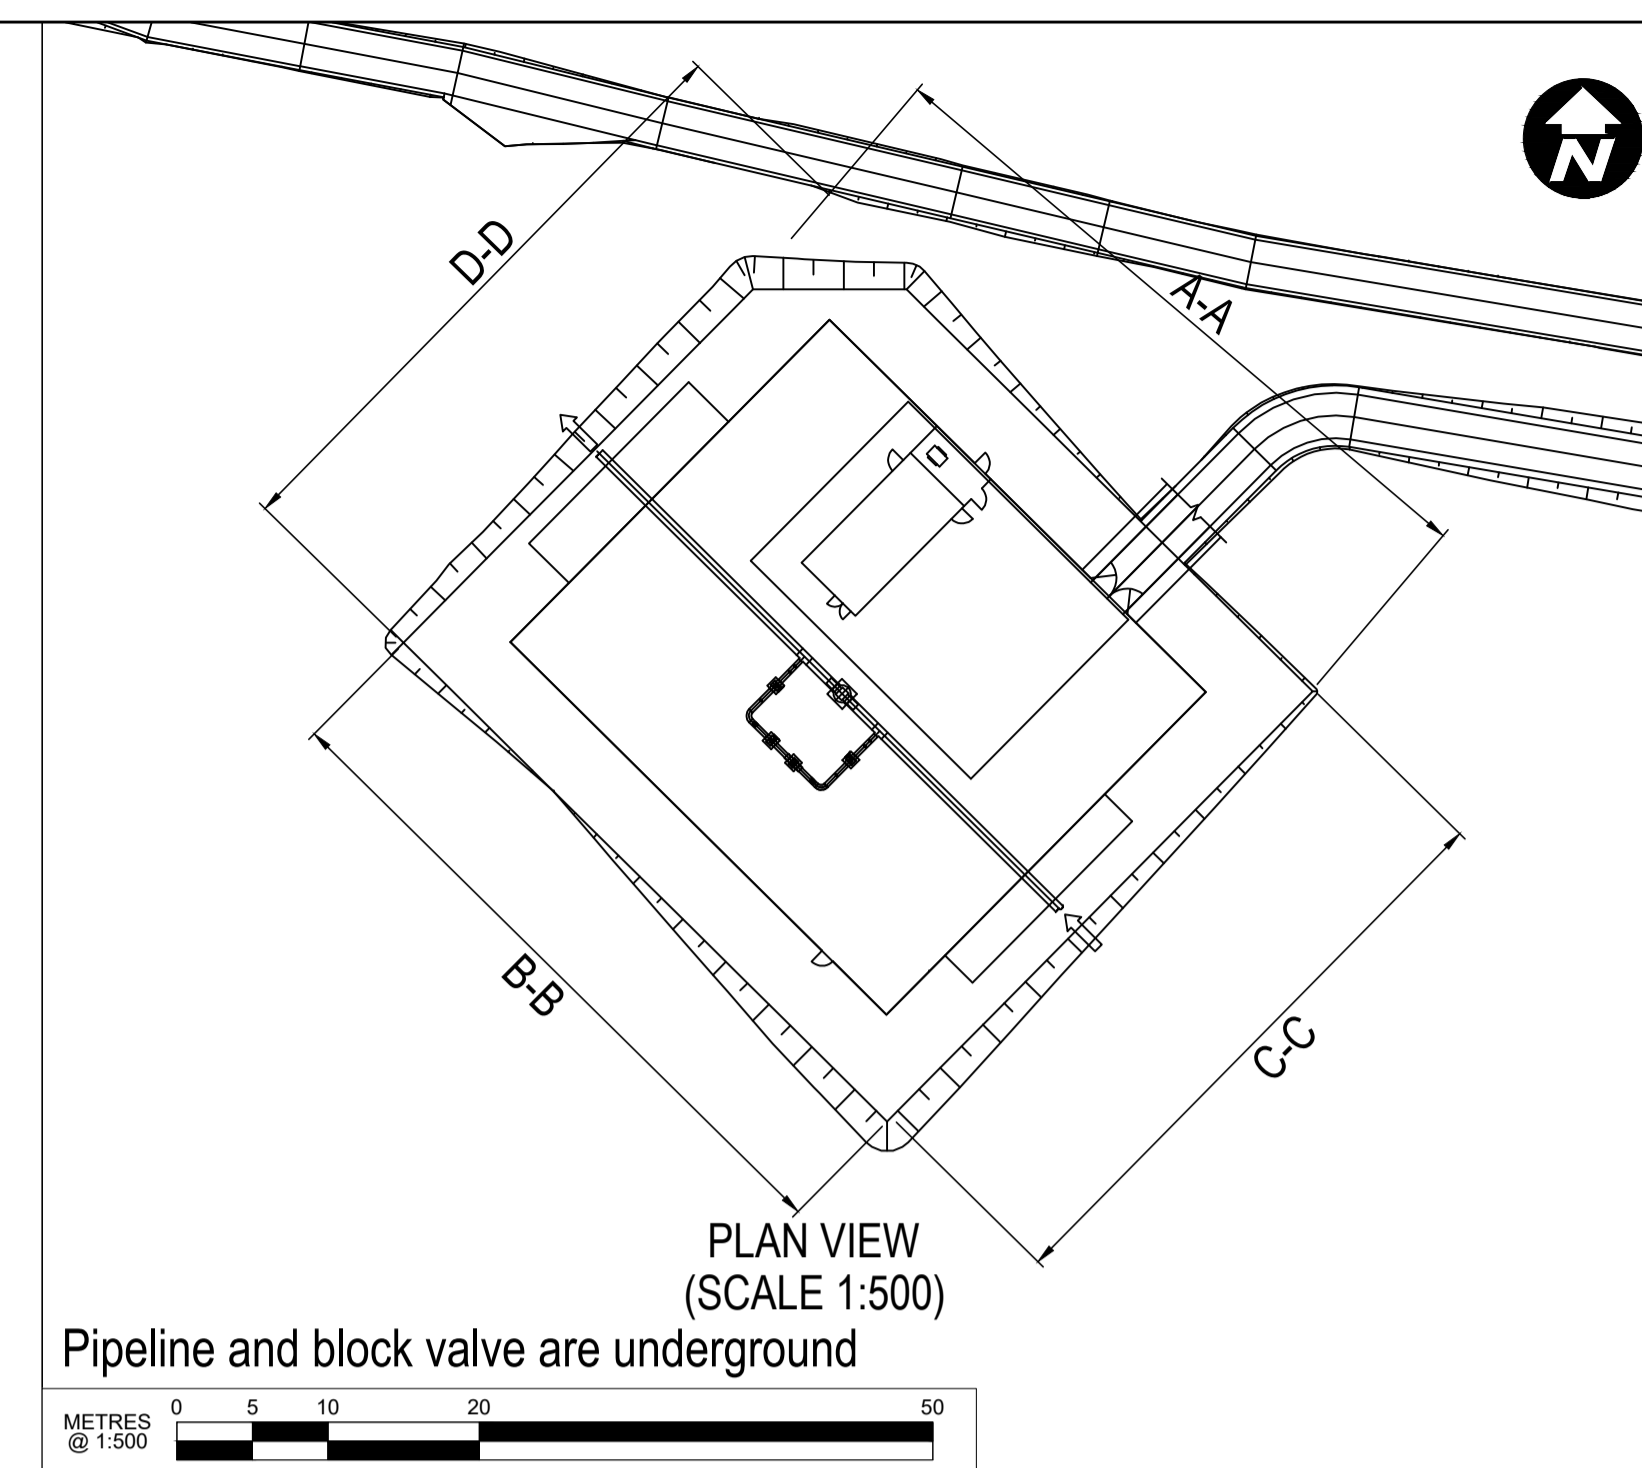

PLAN VIEW
(SCALE 1:500)
Pipeline and block valve are underground

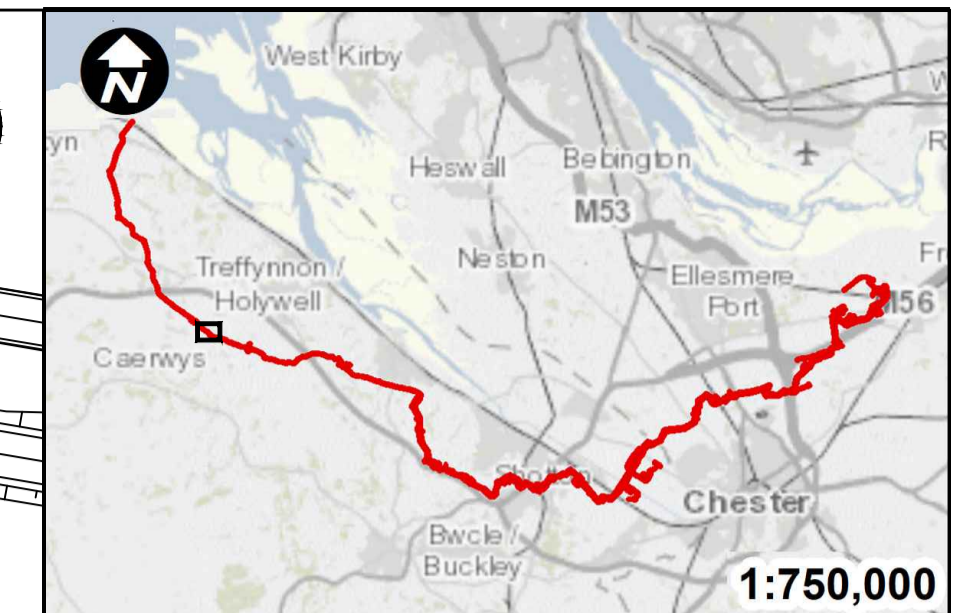

Contains OS data © Crown Copyright and database right 2020

HyNet North West

PROJECT TITLE
HyNet Carbon Dioxide Pipeline DCO

DRAWING TITLE
BABELL BVS
ELEVATION PLAN
REGULATION 5(2)(c)
APPLICATION DOCUMENT REFERENCE D.2.8
SHEET 6 OF 6

DRAWING STATUS
FOR DESIGN CHANGE REQUEST 1

DRAWN TO	CHECKED JH	APPROVED VB	AUTHORISED AV
----------	------------	-------------	---------------

SCALE @ A1 SIZE 1:150	DATE 23/03/2023	REVISION B
--------------------------	--------------------	---------------

DRAWING NUMBER
EN070007-D.2.8-EL-Sheet 6